


# TECHNICAL PORTFOLIO

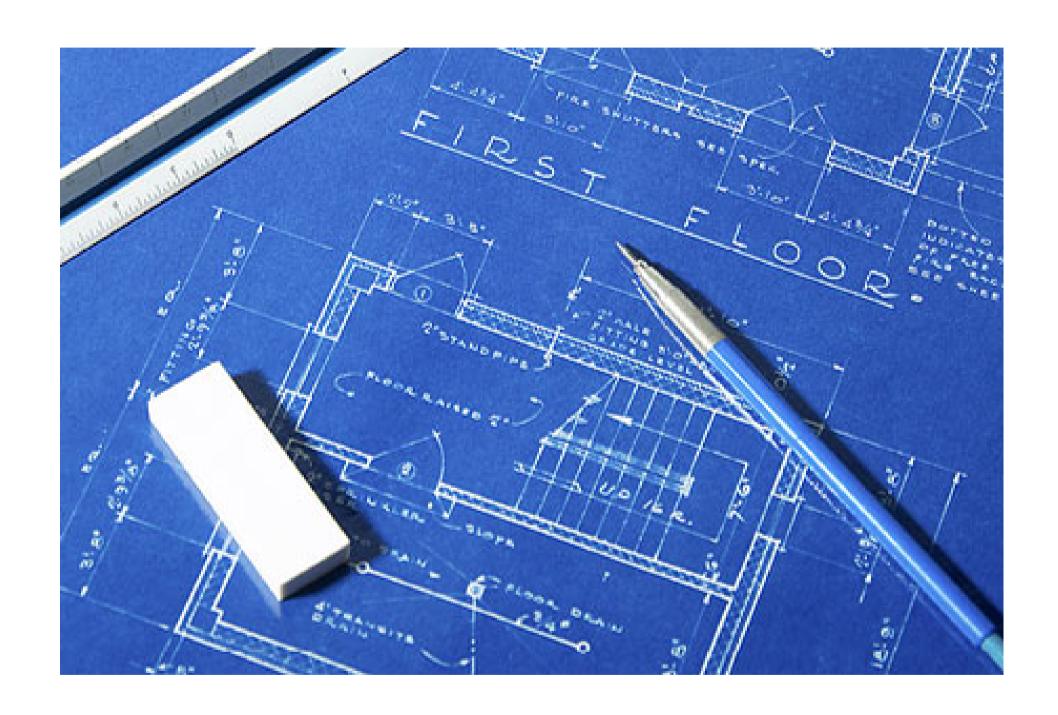

**EXAMPLES** 

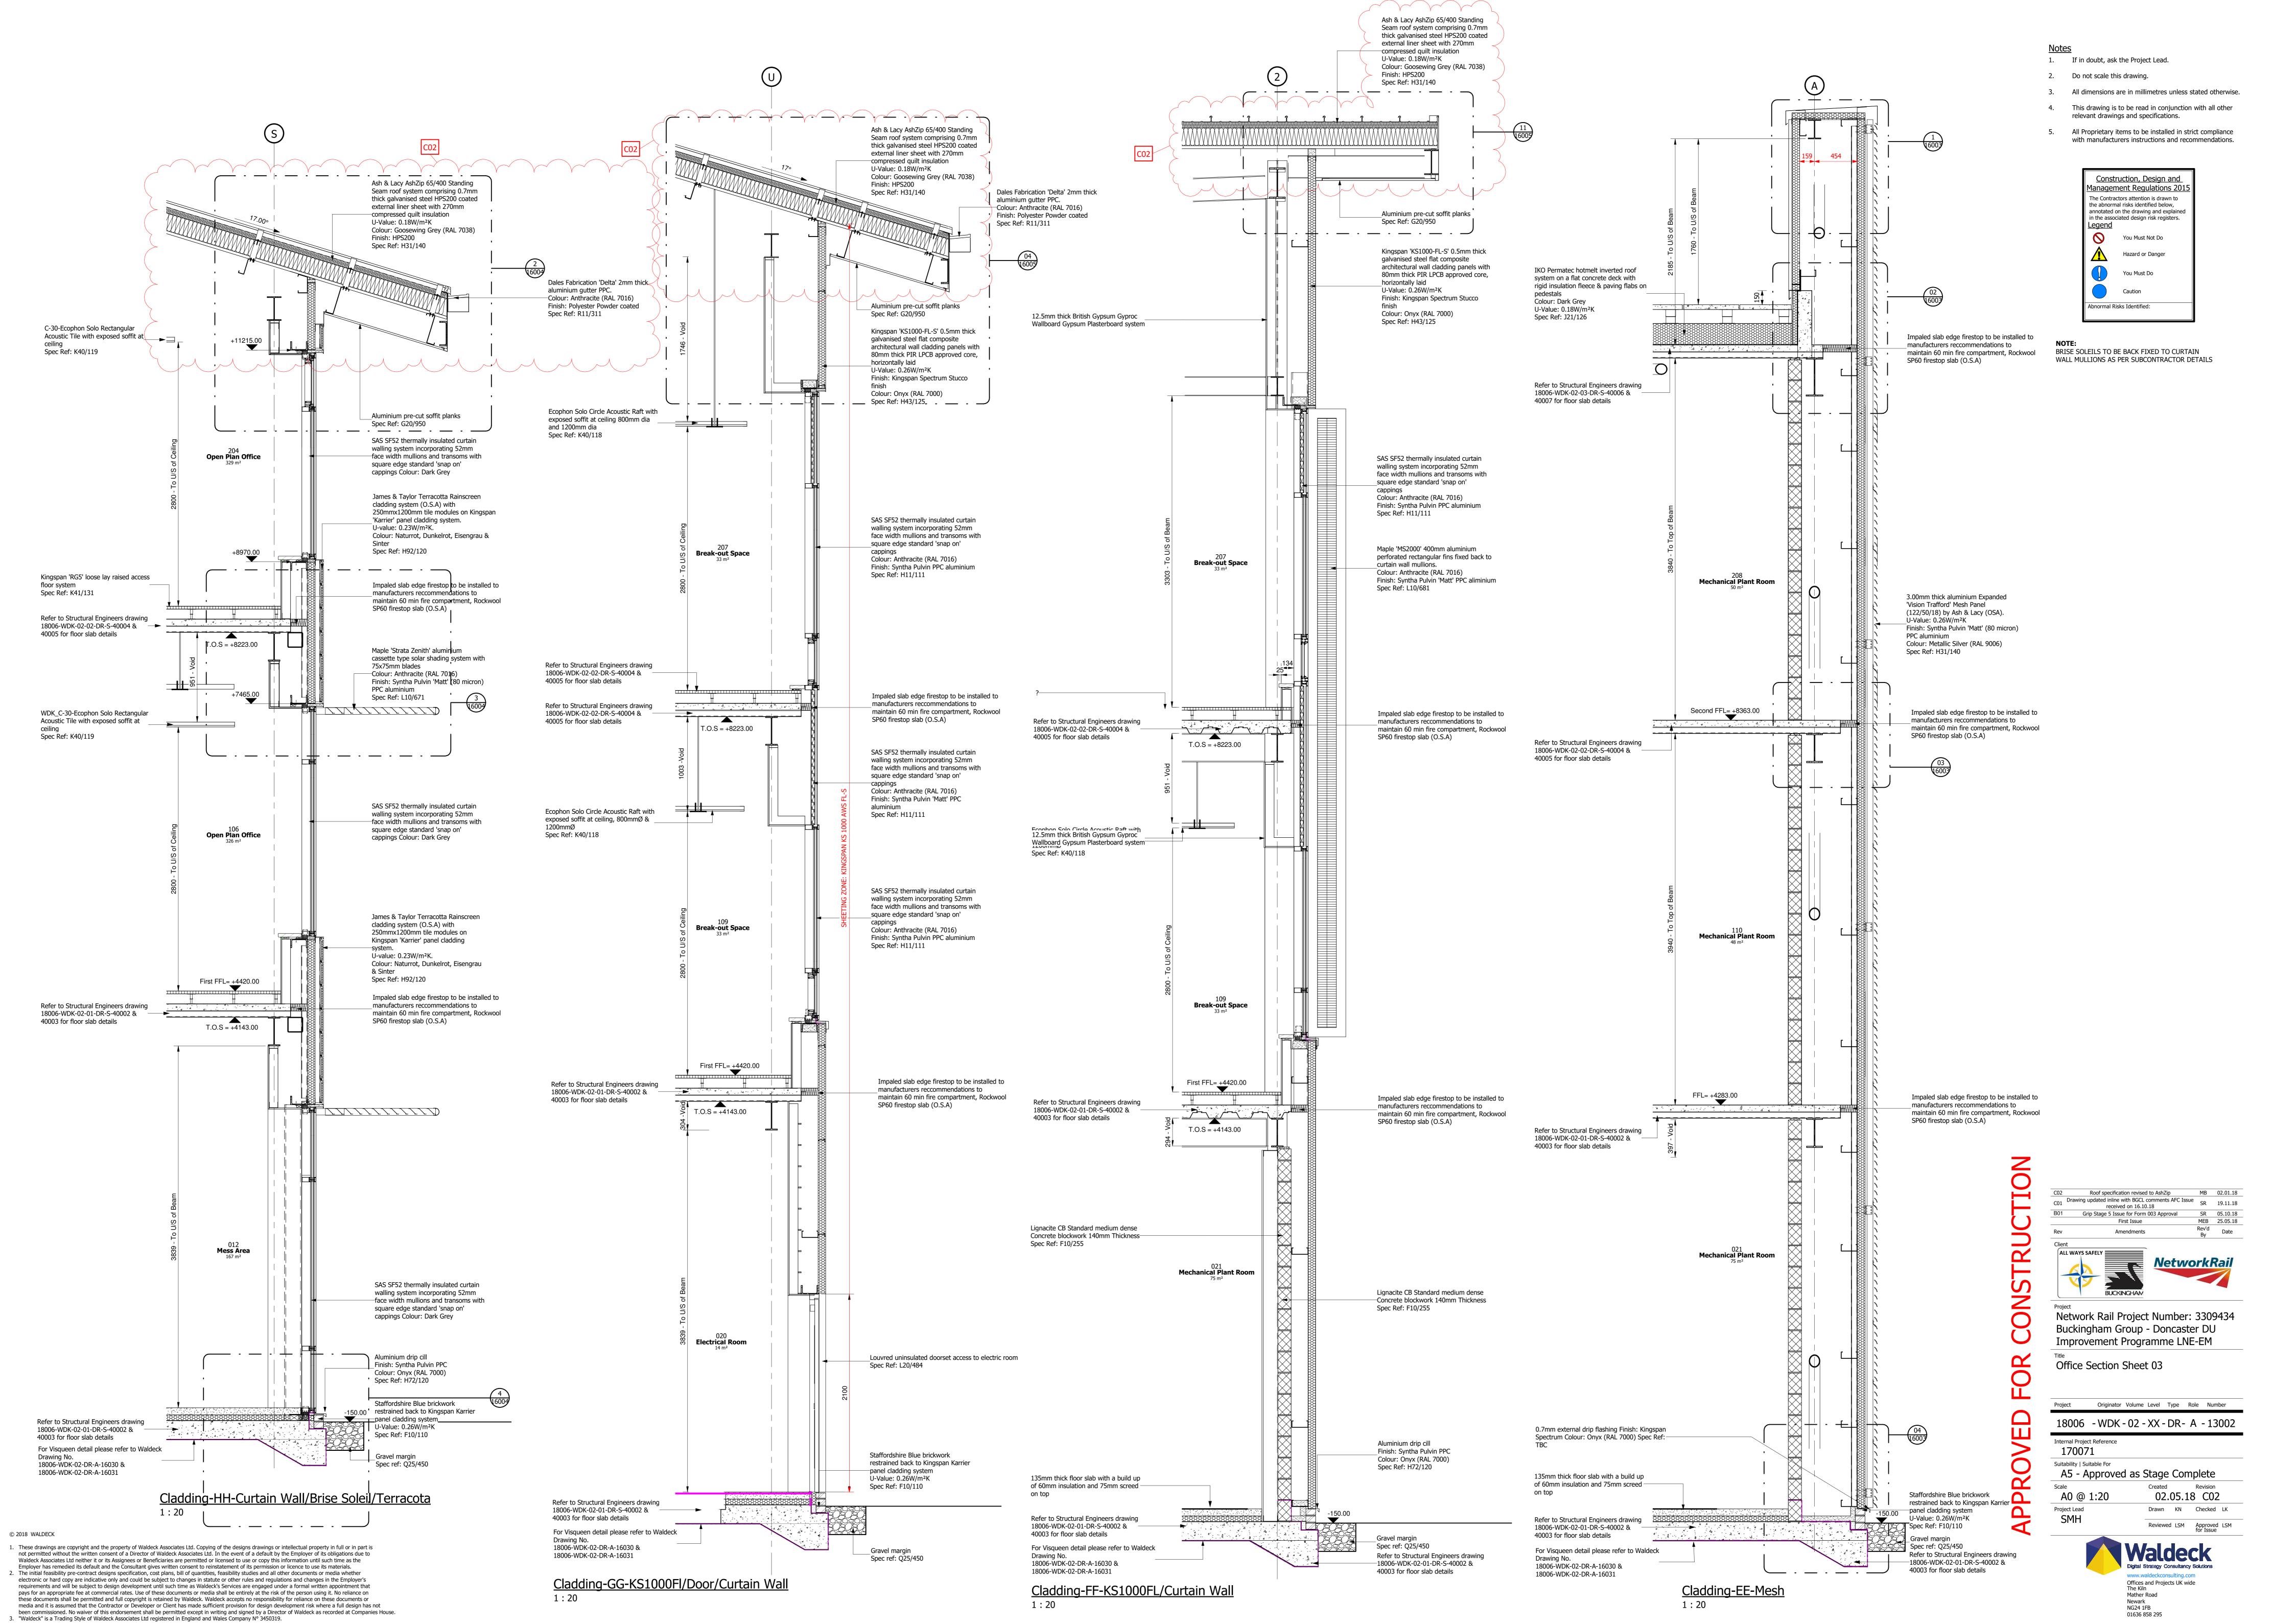

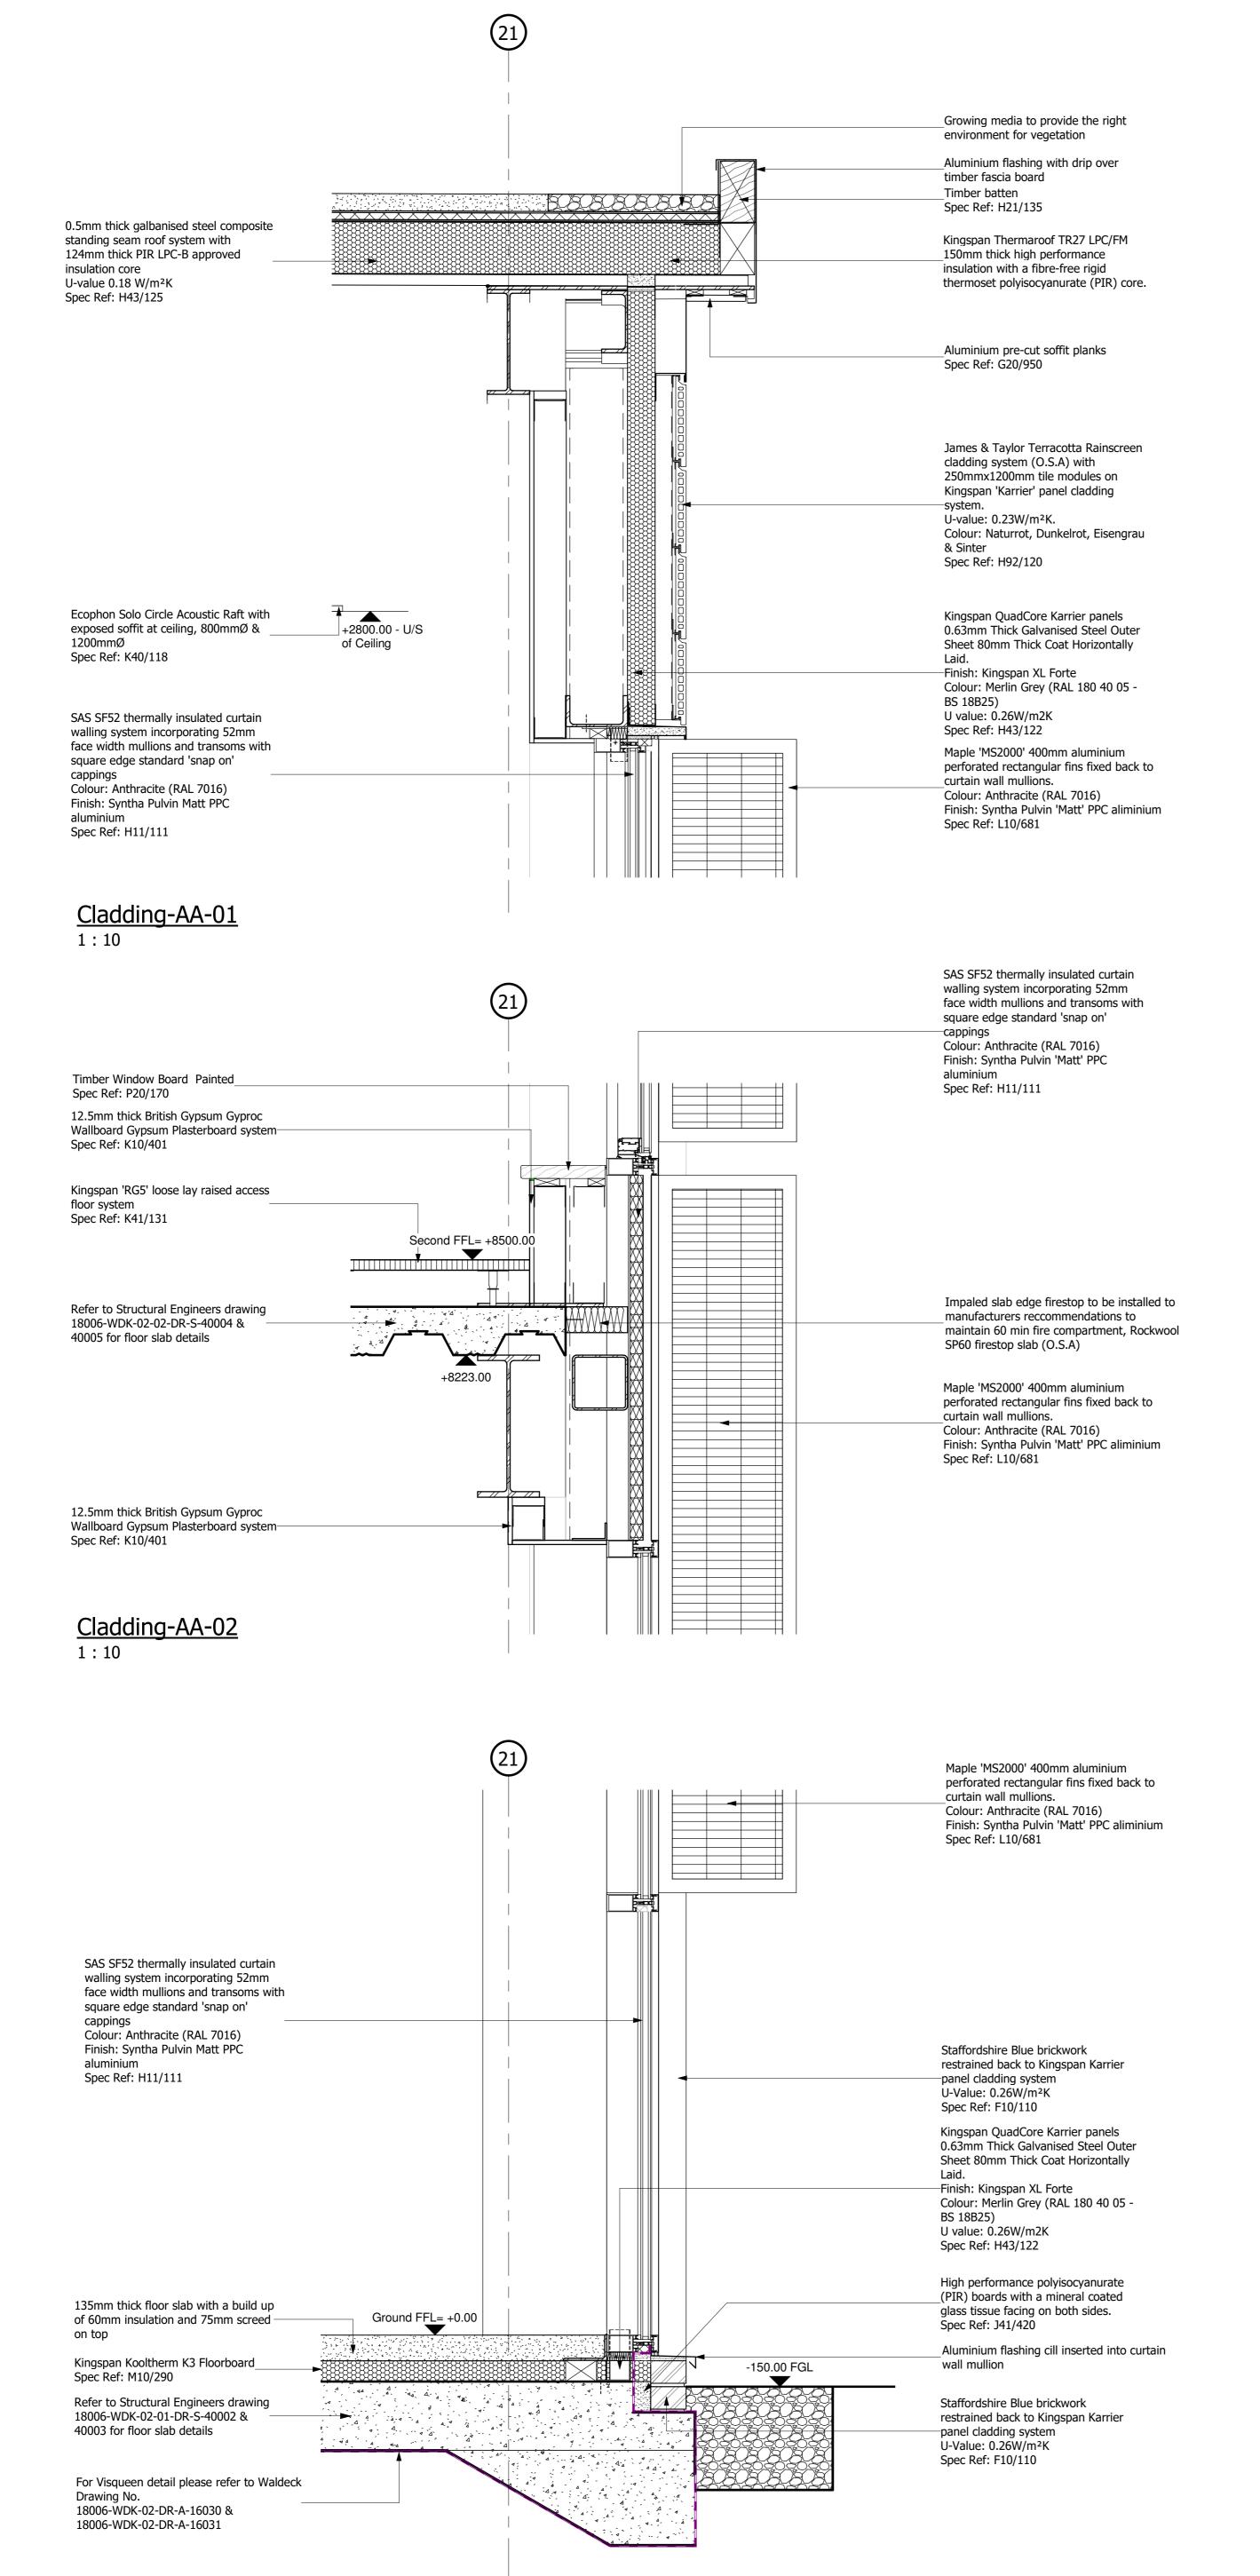



### Cladding-AA-03

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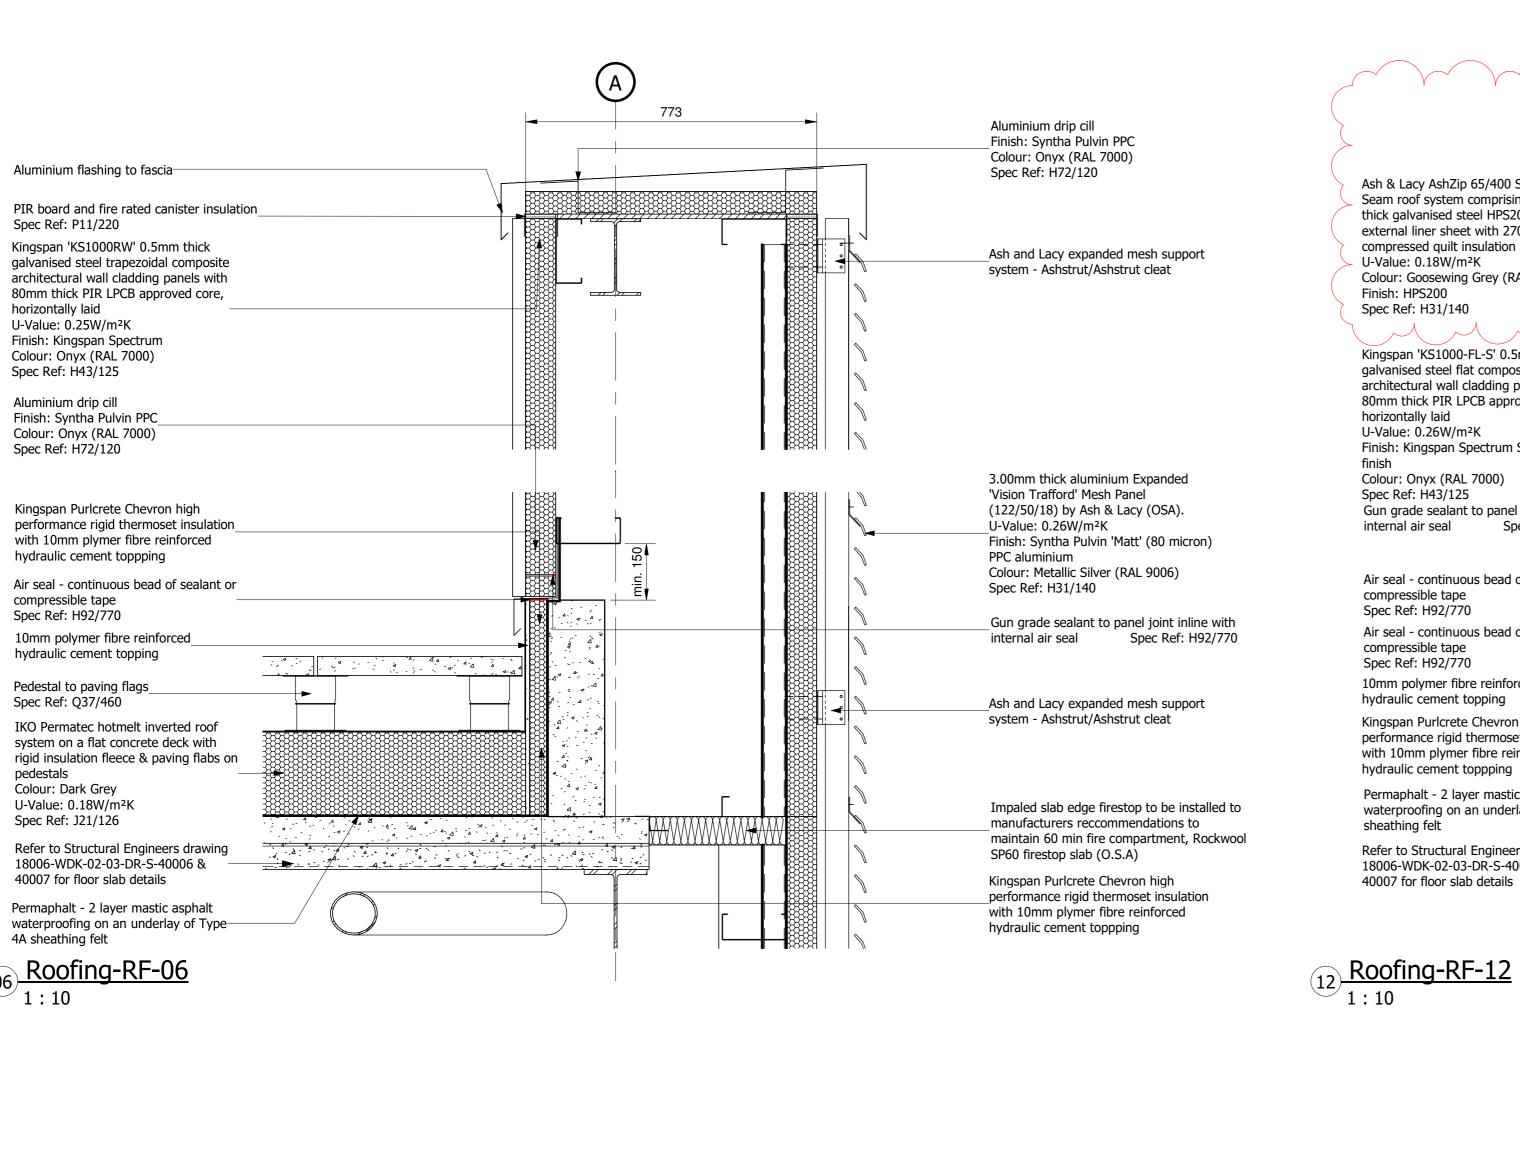



Network Rail Project Number: 3309434 Buckingham Group - Doncaster DU Improvement Programme LNE-EM

Office Details Sheet 01 - AA

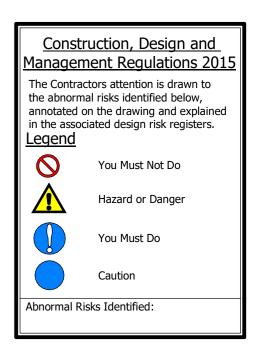Originator Volume Level Type Role Number Project 18006 - WDK - 02 - XX - DR - A - 16000 Internal Project Reference 170071 Suitability | Suitable For A5 - Approved as Stage Complete 02.05.18 C01 A1 @ 1:10 Project Lead Checked LK Drawn SMH Reviewed LSM

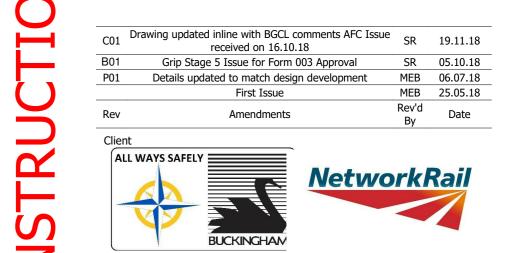



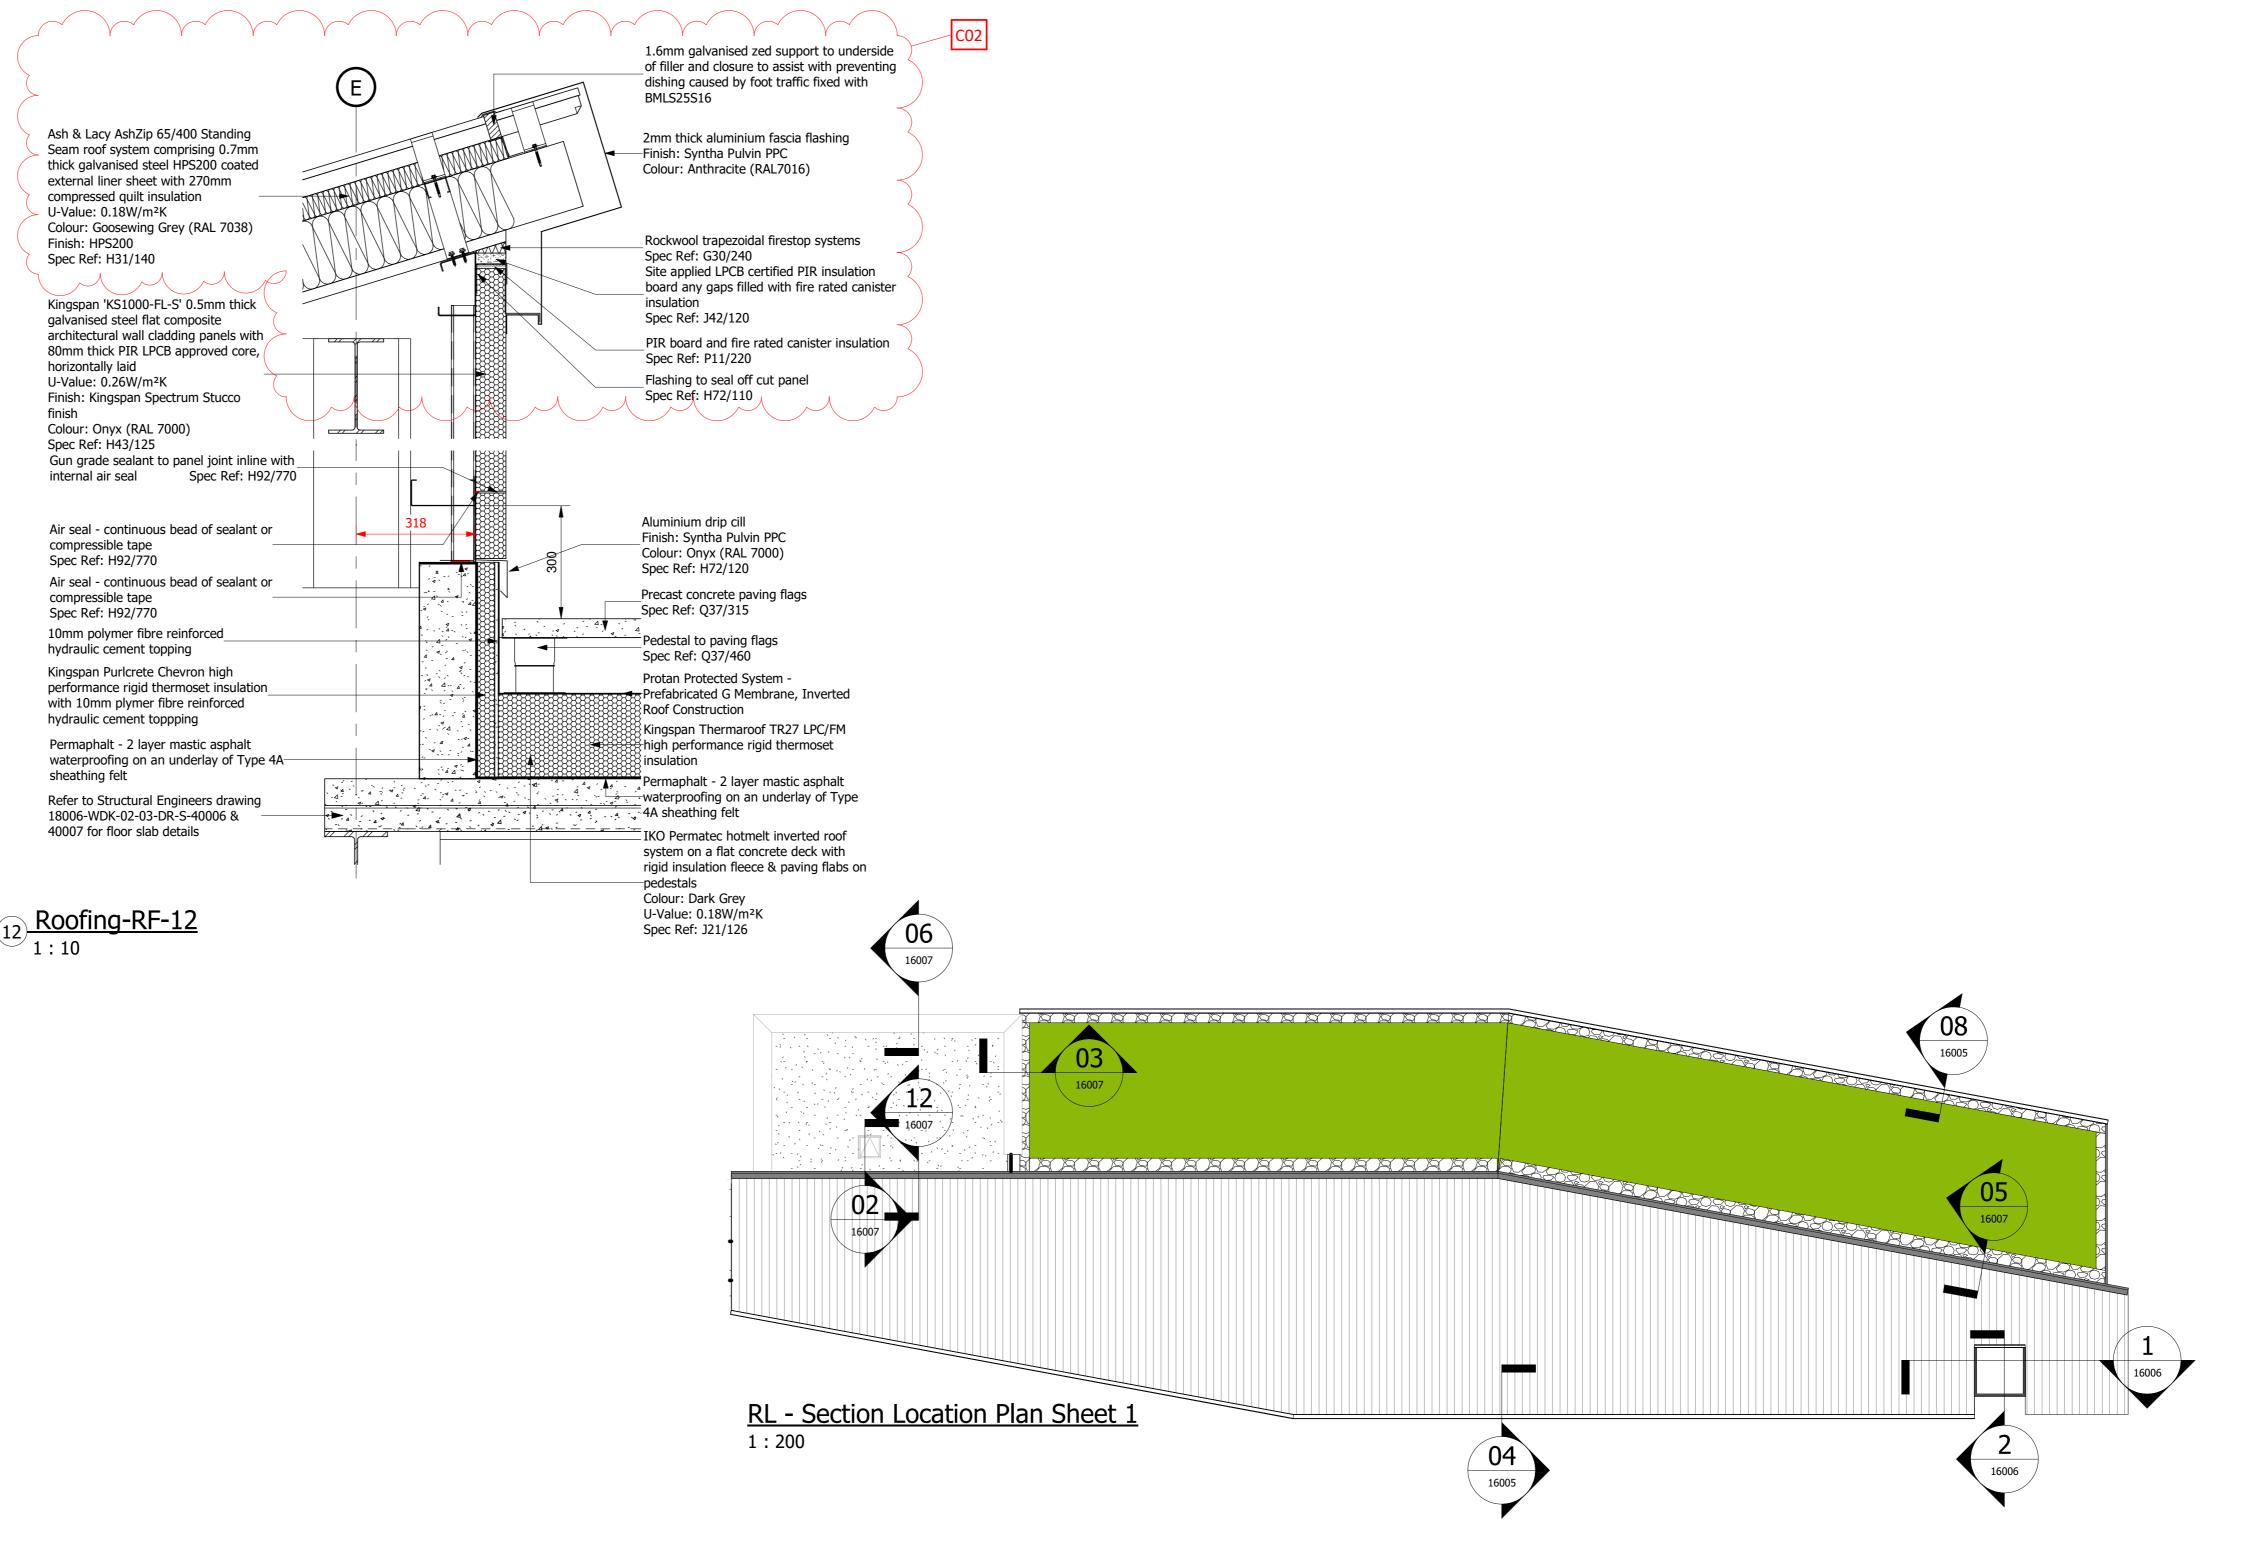

Roofing-RF-03

Drawing updated inline with BGCL comments AFC Issue SR 19.11.18

Network Rail Project Number: 3309434

Buckingham Group - Doncaster DU Improvement Programme LNE-EM

Roof specification revised to AshZip

received on 16.10.18

Grip Stage 5 Issue for Form 003 Approval SR 05.10.18

1. If in doubt, ask the Project Lead.

Construction, Design and Management Regulations 201 The Contractors attention is drawn to the abnormal risks identified below,

annotated on the drawing and explained

in the associated design risk registers

You Must Not Do

Hazard or Danger

You Must Do

Abnormal Risks Identified:

Caution

<u>Legend</u>

3. All dimensions are in millimetres unless stated otherwise.

4. This drawing is to be read in conjunction with all other

5. All Proprietary items to be installed in strict compliance

with manufacturers instructions and recommendations.

relevant drawings and specifications.

Do not scale this drawing.

Office Building Typical Roof Details 01

Originator Volume Level Type Role Number 18006 - WDK - 02 - XX - DR - A - 16007 Internal Project Reference 170071

Suitability | Suitable For A5 - Approved as Stage Complete 08.06.18 C02


Project Lead



01636 858 295

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4 MovablePartition-MPS-2F-AA

Second FFL= +8500.00

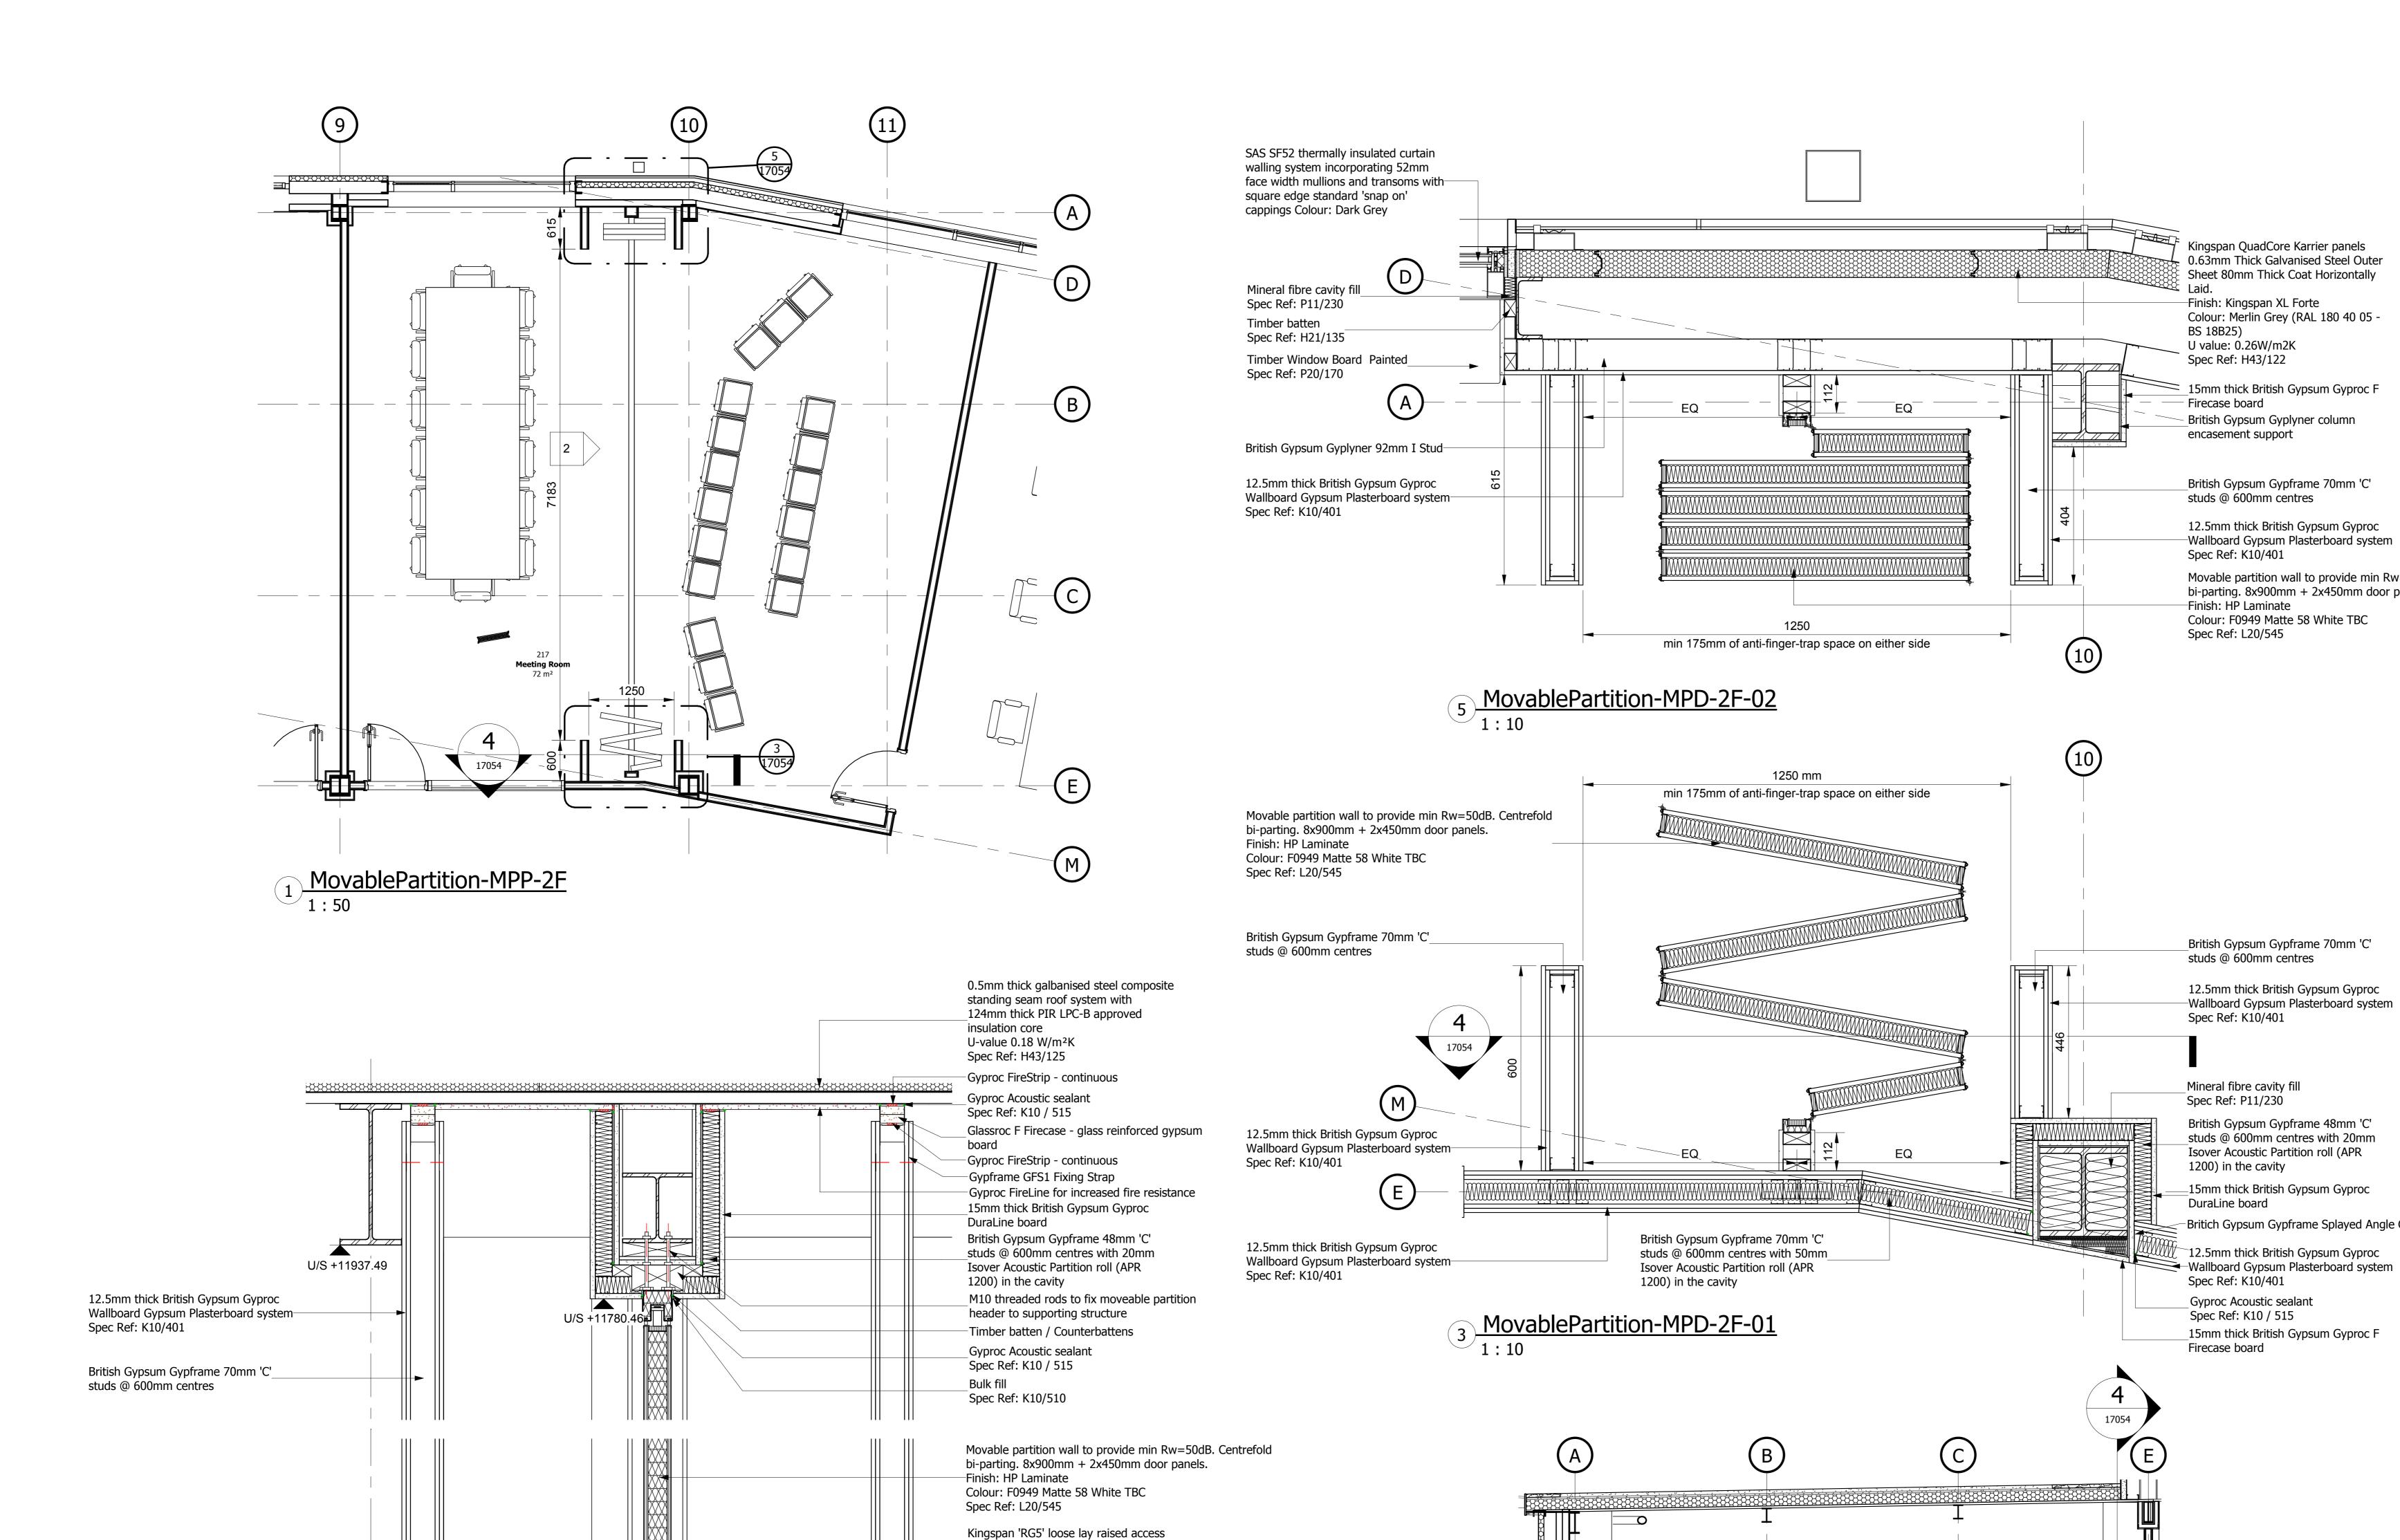Gyproc Acoustic sealant

Spec Ref: K10 / 515

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Bulk fill

Spec Ref: K10/510

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-floor system

Spec Ref: K41/131

layer (in general 5mm).

Raised Access Floor Alpha V Pedestal. Height 20-620mm. Height adjustment -+/- 40mm. Height allowance must be made for cap thickness and adhesive

Refer to Structural Engineers drawing

Kingspan Alpha V pedestals to span 300mm

underneath moveable partition floor track

-18006-WDK-02-02-DR-S-40004 &

40005 for floor slab details

- If in doubt, ask the Project Lead.
- Do not scale this drawing.
- All dimensions are in millimetres unless stated otherwise.
- This drawing is to be read in conjunction with all other relevant drawings and specifications.
- All Proprietary items to be installed in strict compliance with manufacturers instructions and recommendations.

### NOTE:

Kingspan QuadCore Karrier panels

Colour: Merlin Grey (RAL 180 40 05 -

15mm thick British Gypsum Gyproc F

British Gypsum Gypframe 70mm 'C'

12.5mm thick British Gypsum Gyproc -Wallboard Gypsum Plasterboard system

Colour: F0949 Matte 58 White TBC

British Gypsum Gypframe 70mm 'C'

12.5mm thick British Gypsum Gyproc

British Gypsum Gypframe 48mm 'C'

studs @ 600mm centres with 20mm

Isover Acoustic Partition roll (APR

\_15mm thick British Gypsum Gyproc

12.5mm thick British Gypsum Gyproc

\_15mm thick British Gypsum Gyproc F

Kingspan 'RG5' loose lay raised access

Refer to Structural Engineers drawing -- 18006-WDK-02-02-DR-S-40004 &

Raised Access Floor Alpha V Pedestal.

Height 20-620mm. Height adjustment

-+/- 40mm. Height allowance must be made for cap thickness and adhesive

-floor system

Spec Ref: K41/131

40005 for floor slab details

layer (in general 5mm).

-Britich Gypsum Gypframe Splayed Angle GA6

-Wallboard Gypsum Plasterboard system

studs @ 600mm centres

Spec Ref: K10/401

Mineral fibre cavity fill

Spec Ref: P11/230

1200) in the cavity

DuraLine board

Spec Ref: K10/401

Spec Ref: K10 / 515

Firecase board

Clear opening between pocket walls

Second FFL= +8500.00

MovablePartition-MPE-2F-A

Gyproc Acoustic sealant

Movable partition wall to provide min Rw=50dB. Centrefold

bi-parting. 8x900mm + 2x450mm door panels.

British Gypsum Gyplyner column

Finish: Kingspan XL Forte

U value: 0.26W/m2K Spec Ref: H43/122

encasement support

studs @ 600mm centres

Spec Ref: K10/401

Finish: HP Laminate

Spec Ref: L20/545

Firecase board

BS 18B25)

0.63mm Thick Galvanised Steel Outer Sheet 80mm Thick Coat Horizontally

> Kingspan Europed pedestal has been changed to Alpha V

Construction, Design and Management Regulations 201 The Contractors attention is drawn to the abnormal risks identified below, annotated on the drawing and explained in the associated design risk registers. <u>Legend</u> You Must Not Do Hazard or Danger You Must Do Caution Abnormal Risks Identified:





AFC Issue



MB 19.11.18

Date

Network Rail Project Number: 3309434 Buckingham Group - Doncaster DU Improvement Programme LNE-EM

Office Second Floor Movable Partition Layout & Details

Originator Volume Level Type Role Number

18006 - WDK - 02 - 02 - DR - A - 17054

Internal Project Reference 170071

Suitability | Suitable For


A5 - Approved as Stage Complete

31.07.18 C01 A1 @ 1:50 Project Lead Drawn SR Checked MB SMH



01636 858 295

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Construction, Design and

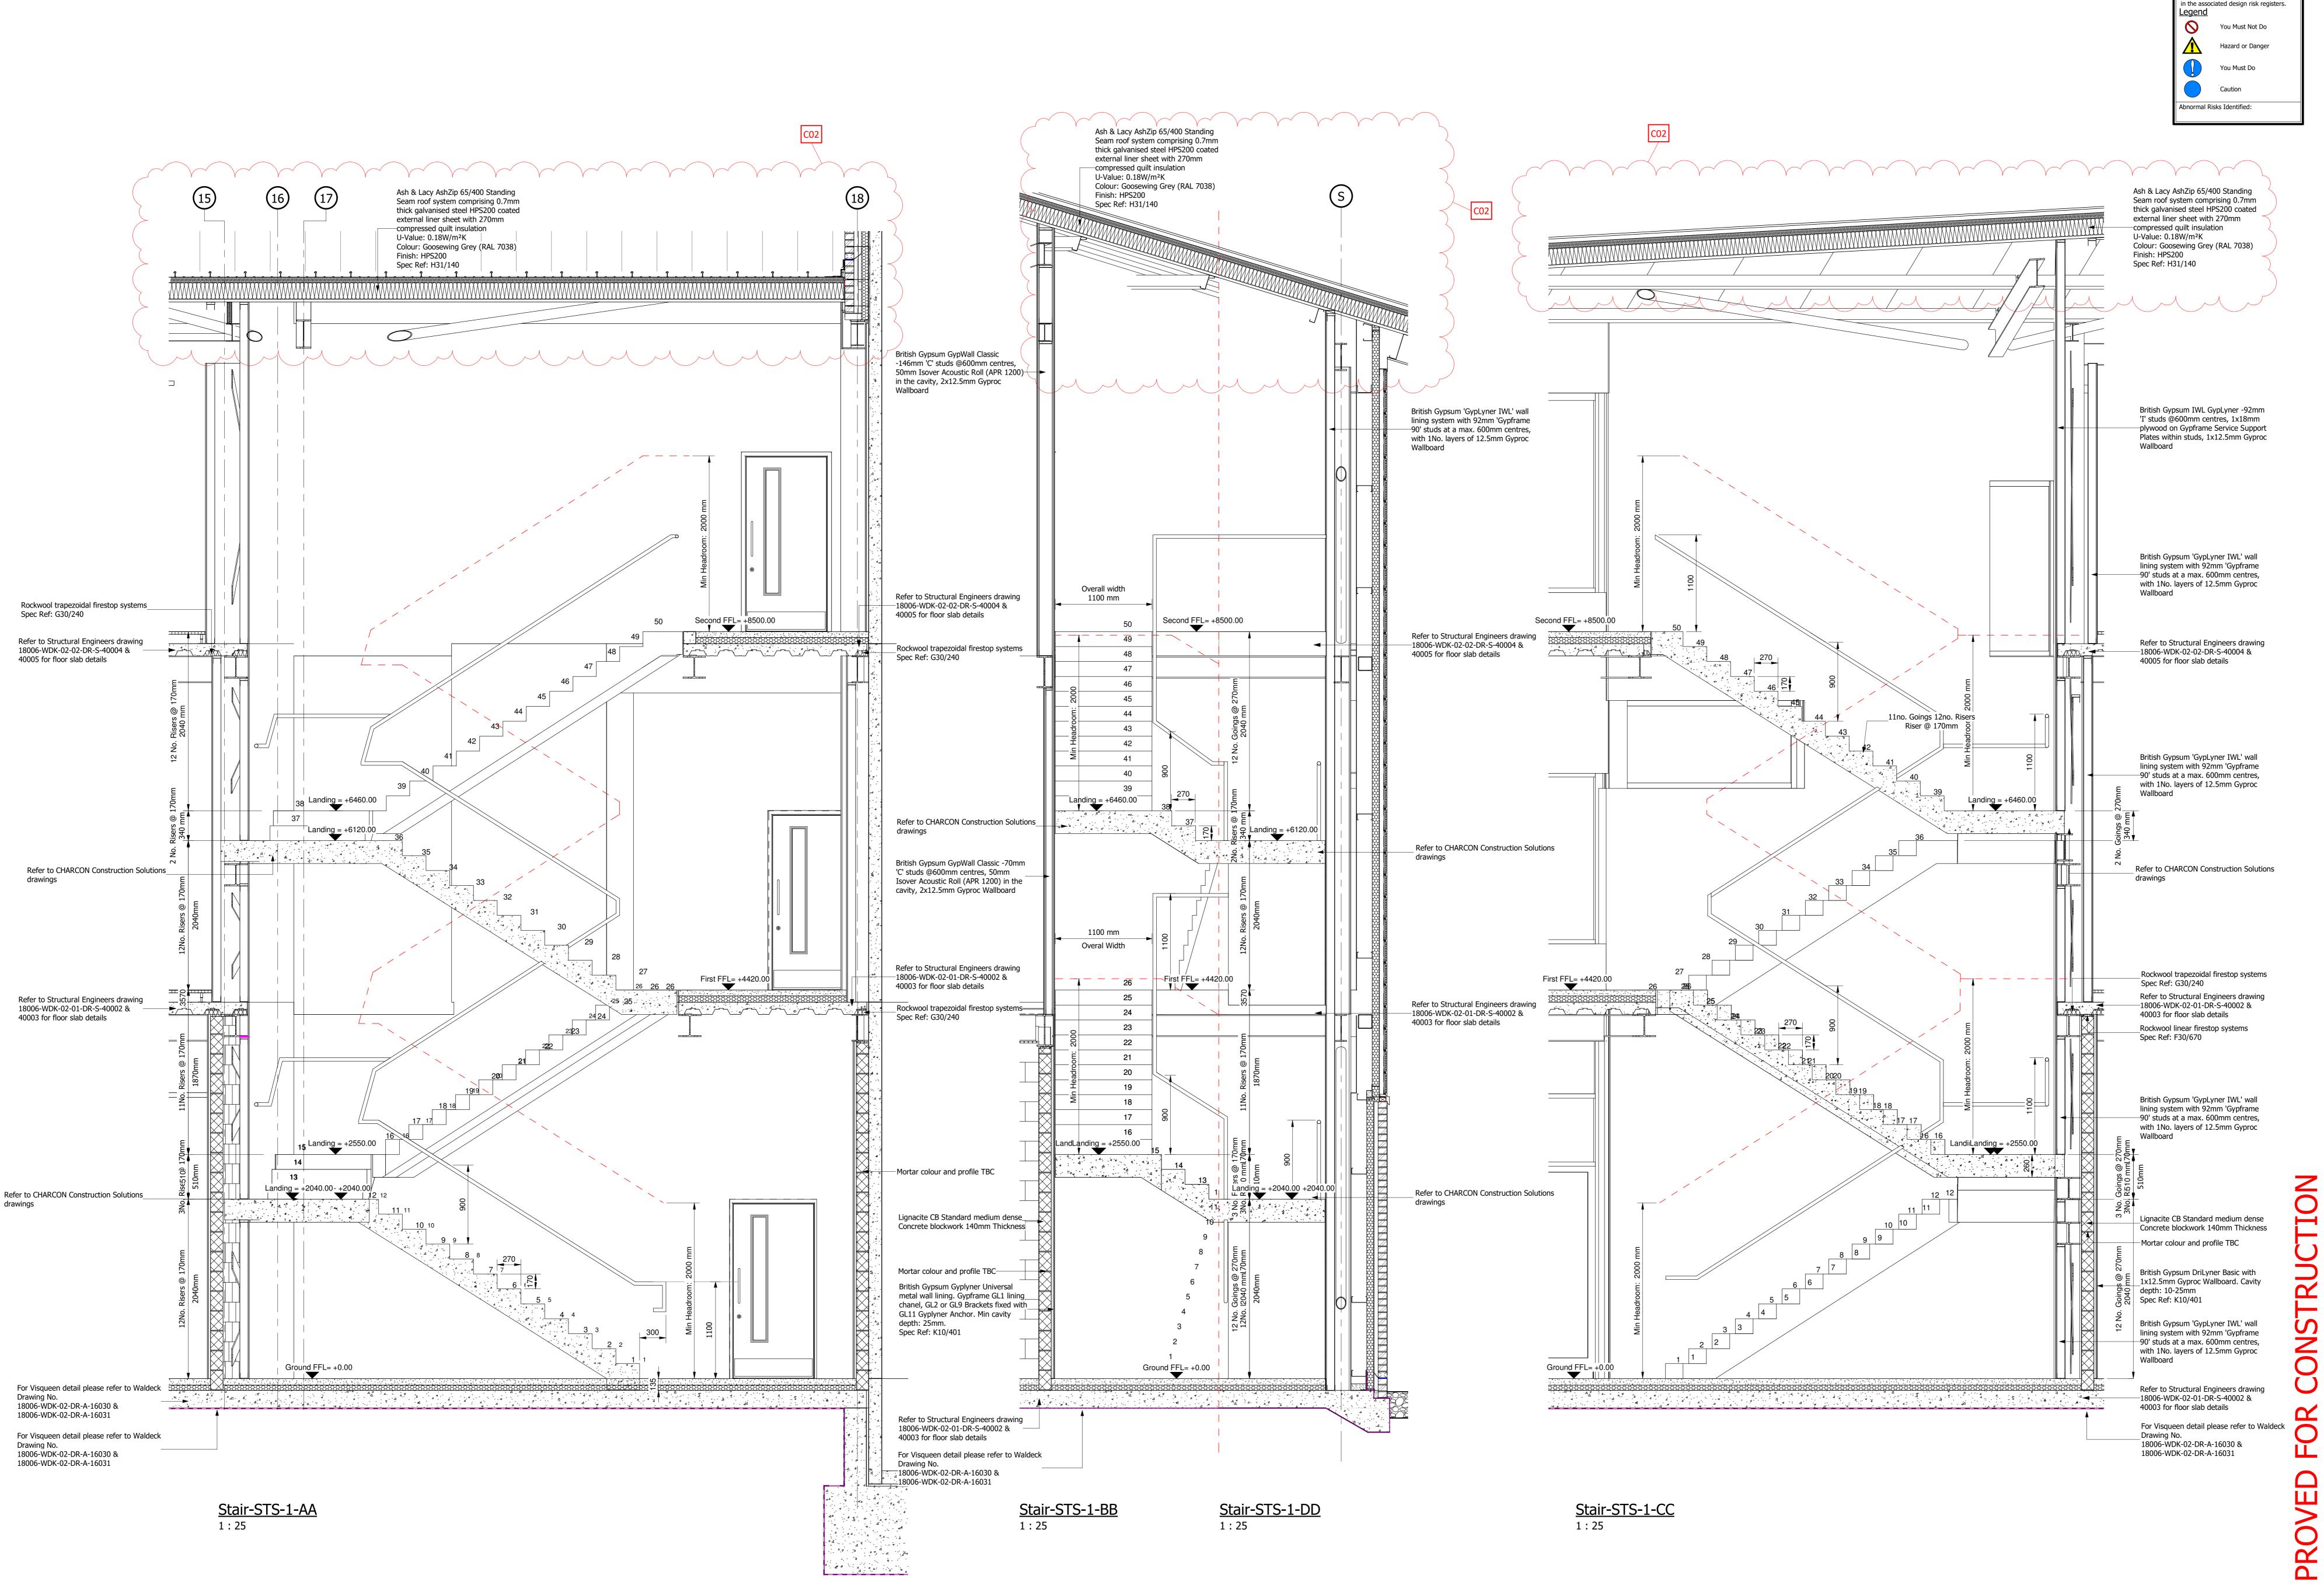Management Regulations 201 The Contractors attention is drawn to

annotated on the drawing and explained

the abnormal risks identified below,

1. If in doubt, ask the Project Lead.

Do not scale this drawing.

3. All dimensions are in millimetres unless stated otherwise.

4. This drawing is to be read in conjunction with all other relevant drawings and specifications.

All Proprietary items to be installed in strict compliance with manufacturers instructions and recommendations.

Staircases to be precast concrete designed to BS 8110:1997 with type A finish to soffits, risers and sides. Screed landings to structural engineers design.

comply with Approved Document B.

Stair and landing to be designed in accordance with Approved Document M for Ambulant Design, with a minimum clear width between handrails of 1300mm to

40mm handrail and uprights by Delta Balustrades from the Orbis range, to be Polyester Powder Coated to BS EN ISO 1461:1999

Height to top of handrail above stair pitch line to be 900mm Height to top of handrail above landing to be 1100mm Design Loadings (BS 6180:2008) Horizontal uniform distributed line load = 0.74kN/m UDL applied

infill = 1.0kN/m2 Point load applied to infill = 0.5kN 10. All levels are to be verified on site by the contractor prior

to preparation of fabrication drawings

11. All connections to be contractor designed

12. Handrails to be contractor designed

13. Gradus Trans-Edge type 'TEX51' heavy duty stair nosings

are to be provided to all nosings and fixed in accordance with manufactures details and specification Finish: TBC

14. All proprietary items to be installed in strict compliance with manufacturer's instructions and recommendations.

Final steelwork positions to be confirmed

Roof specification revised to AshZip Drawing updated inline with BGCL comments AFC Issue SR 19.11.18 Grip Stage 5 Issue for Form 003 Approval General Drawing Update Drawing updated to suit comments received First Issue



Network Rail Project Number: 3309434 Buckingham Group - Doncaster DU Improvement Programme LNE-EM

Office Stair 1 Sections & Details

Originator Volume Level Type Role Number

18006 - WDK - 02 - XX - DR - A - 16012 Internal Project Reference 170071


Suitability | Suitable For A5 - Approved as Stage Complete


07.06.18 C02 Project Lead



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1 External Envelope Details Location Plan

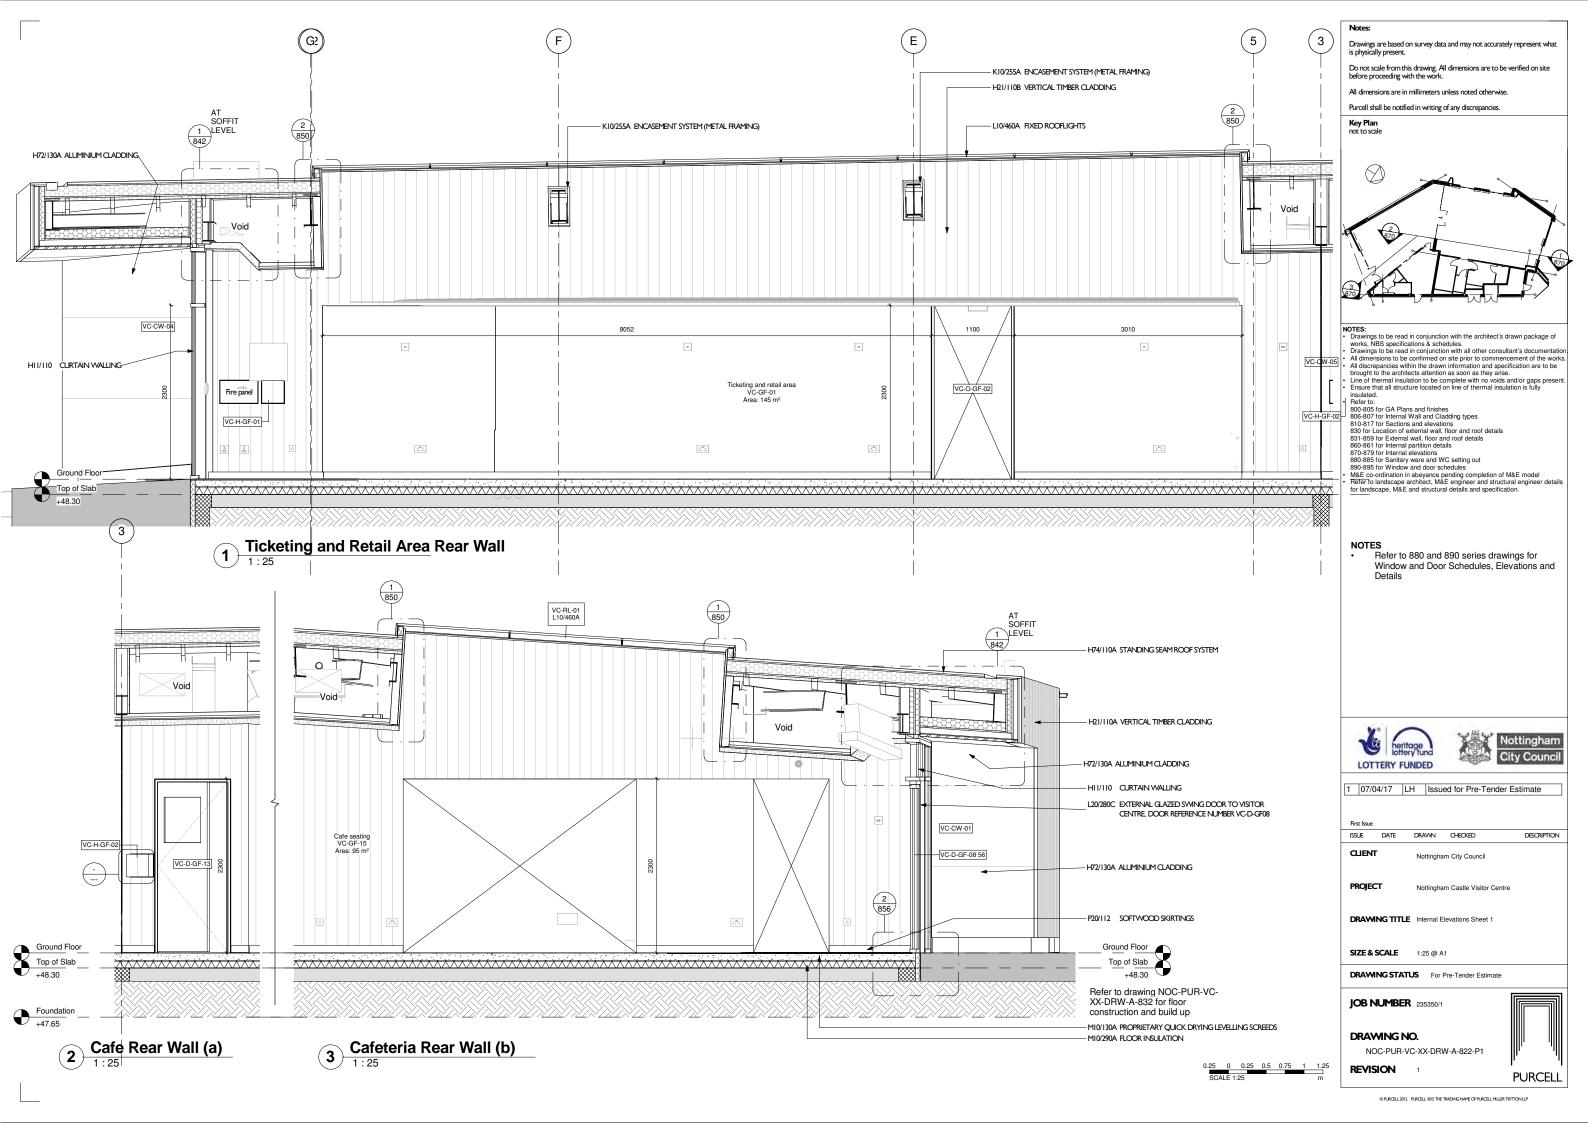


Notes:

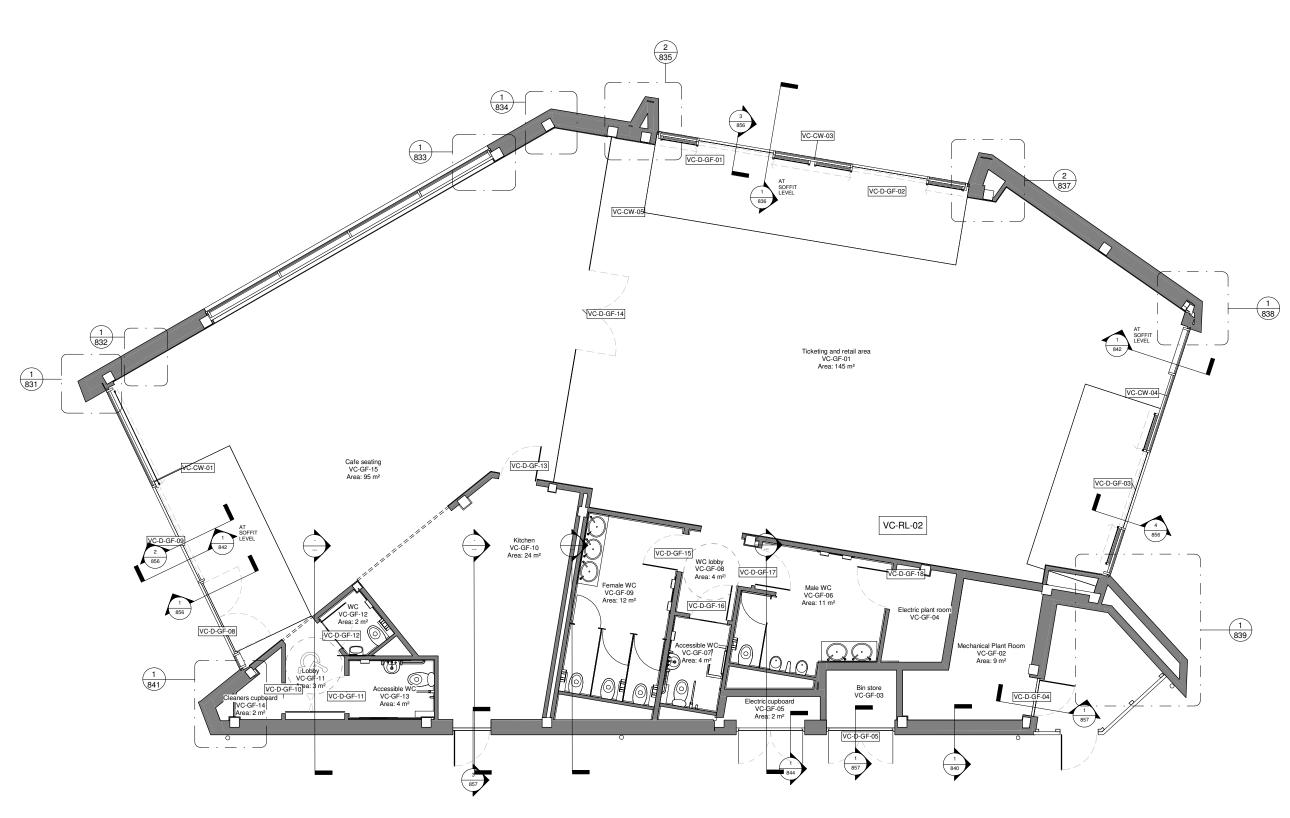Drawings are based on survey data and may not accurately represent what is physically present.

Do not scale from this drawing. All dimensions are to be verified on site before proceeding with the work.

All dimensions are in millimeters unless noted otherwise.

Purcell shall be notified in writing of any discrepancies.

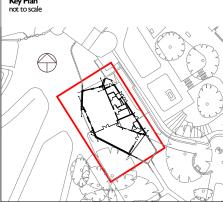

- NOTES:

  Drawings to be read in conjunction with the architect's drawn package of works, NBS specifications & schedules.

  Drawings to be read in conjunction with all other consultant's documentation. All dimensions to be confirmed on site prior to commencement of the works.

  All discrepancies within the drawn information and specification are to be brought to the architects attention as soon as they arise.

  Line of thermal insulation to be complete with no voids and/or gaps present.

  Ensure that all structure located on line of thermal insulation is fully insulated.

  Refer to:
  800-805 for GA Plans and finishes
  806-807 for Internal Wall and Cladding types
  810-817 for Sections and elevations
  831 6-85 for External wall, floor and roof details
  880-861 for Internal partition details
  8870-879 for Internal elevations
  880-885 for Samilary ware and WC setting out
  880-885 for Samilary ware and WC setting out
  880-885 for Window and door schedules

  M&E co-ordination in abeyance pending completion of M&E model
  Refer to landscape architect, M&E engineer and structural engineer details for landscape, M&E and structural details and specification.





1 07/04/17 LH Issued for Pre-Tender Estimate

ISSUE DATE DRAWN CHECKED DESCRIPTION

CLIENT Nottingham City Council

PROJECT

**DRAWING TITLE** Location Plan for External Details

SIZE & SCALE 1:50 @ A1

**DRAWING STATUS** For Pre-Tender Estimate


JOB NUMBER 235350/1

DRAWING NO.


NOC-PUR-VC-GF-DRW-A-830-P1

REVISION




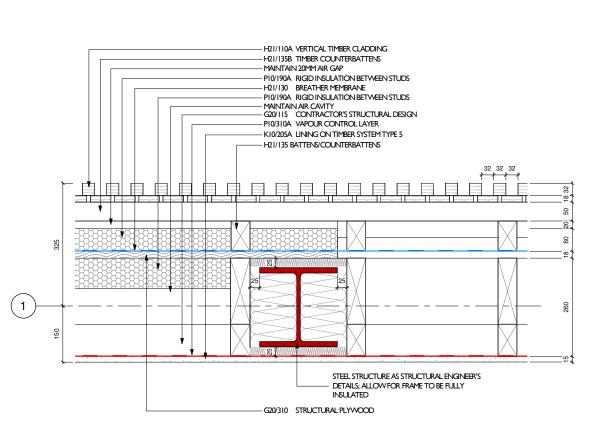

### External Envelope Detail 02 - Plan - Cladding

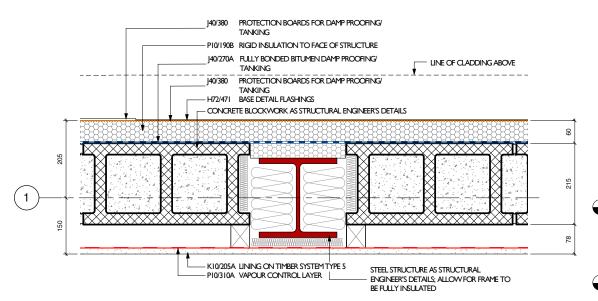

External Envelope Detail 02 - Plan - Base

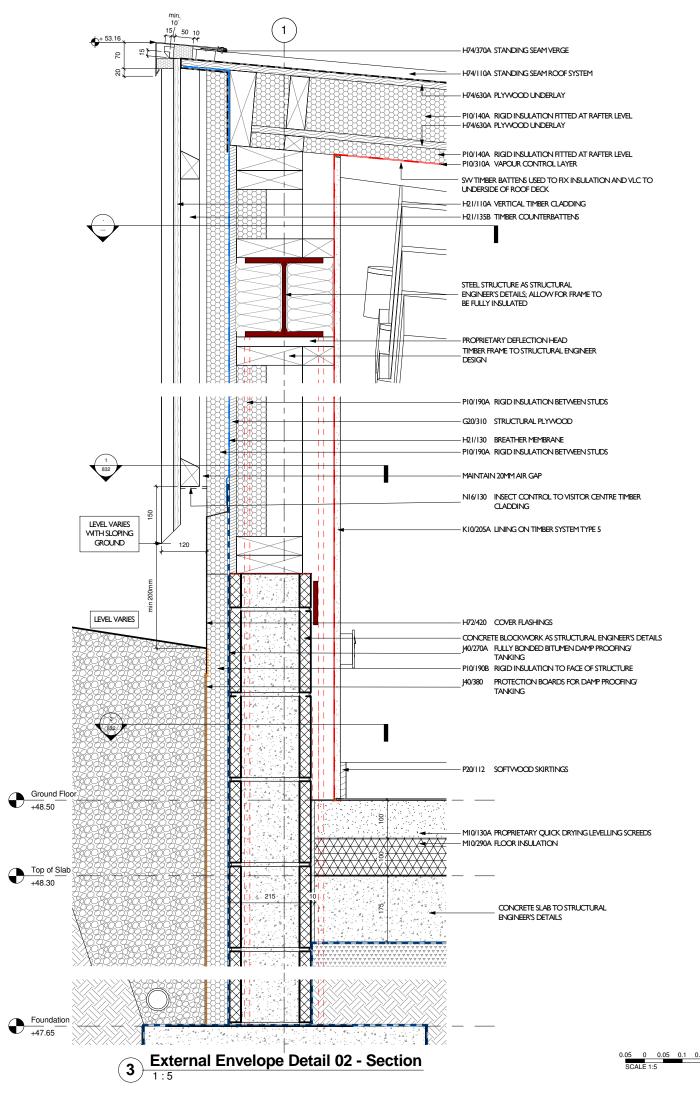


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  Line of thermal insultation to be complete with no voids and/or gaps present.
  Ensure that all structure located on line of thermal insulation is fully

Refer to:

800-805 for GA Plans and finishes
806-807 for Internal Wall and Cladding types
810-817 for Sections and elevations
830 for Location of external wall, floor and roof details
831-859 for External wall, floor and roof details
831-859 for External wall, floor and roof details
860-861 for Internal partition details
870-879 for Internal elevations
880-885 for Sanitary ware and WC setting out
890-895 for Window and door schedules
M&E co-ordination in abeyance pending completion of M&E model
Refer to landscape architect, M&E engineer and structural engineer
for landscape, M&E and structural details and specification.

DETAIL KEY:

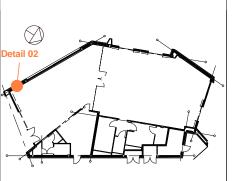J40/270A FULLY BONDED BITUMEN DAMP PROOFING/ TANKING

**-** J40/120 LOOSE LAID POLYETHYLENE DAMP PROOFING

PROPRIETARY ROOF MEMBRANE

PI0/310A VAPOUR CONTROL LAYER

— H21/130 BREATHER MEMBRANE

J40/380 PROTECTION BOARDS FOR DAMP PROOFING/ TANKING





1 07/04/17 LH Issued for Pre-Tender Estimate

ISSUE DATE DRAWN CHECKED DESCRIPTION

CLIENT Nottingham City Council

PROIECT

DRAWING TITLE External Envelope Detail 02

SIZE & SCALE 1:5 @ A1 DRAWING STATUS For Pre-Tender Estimate


JOB NUMBER 235350/1

DRAWING NO.

NOC-PUR-VC-XX-DRW-A-832-P1

REVISION



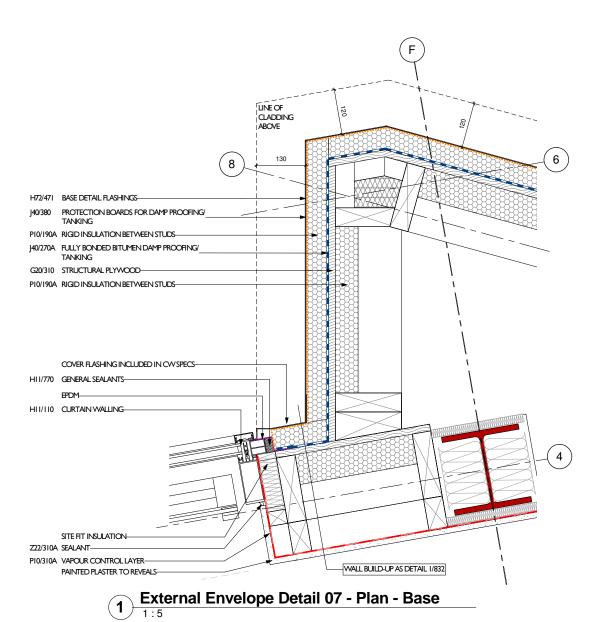

H21/110A VERTICAL TIMBER CLADDING-H72/420 COVER FLASHINGS-STEEL ANGLE SUPPORT AS COP ITEM-H92/110A METAL CLADDING (8) PROPRIETARY BRACKET BY CLADDING SUPPLIER AS CDP ITEM PI0/190A RIGID INSULATION BETWEEN STUDS-H21/130 BREATHER MEMBRANE-G20/310 STRUCTURAL PLYWOOD-PIO/190A RIGID INSULATION BETWEEN STUDS-H72/420 COVER FLASHINGS-HII/770 GENERAL SEALANTS-SITE FIT INSULATION-HII/II0 CURTAIN WALLING PI0/310A VAPOUR CONTROL LAYER PAINTED PLASTER TO REVEALS-External Envelope Detail 07 - Plan - Cladding

PROPRIETARY BRACKET BY CLADDING SUPPLIER AS COP ITEM H92/110A METAL CLADDING-PROPRIETARY VENTILATED SECTION
PERFORATED SHEET TO LOOSE PPC FINISH-COLOUR TBC. H72/420 COVER FLASHINGS-PIO/190A RIGID INSULATION BETWEEN STUDS-Ground Floor +48.50 J40/380 PROTECTION BOARDS FOR DAMP PROOFING/ TANKING PI0/190B RIGID INSULATION TO FACE OF STRUCTURE-J40/270A FULLY BONDED BITUMEN DAMP PROOFING/


**External Envelope Detail 07 - Section** 

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  Drawings to be read in conjunction with all other consultant's documentation. All dimensions to be confirmed on site prior to commencement of the works. All discrepancies within the drawn information and specification are to be brought to the architects attention as soon as they arise.

  Line of thermal insulation to be complete with no voids and/or gaps present. Ensure that all structure located on line of thermal insulation is fully insulated.
- Ensure that all structure located on line of thermal insulation is fully insulated.

  Refer to:
  800-805 for GA Plans and finishes
  806-807 for Internal Wall and Cladding types
  810-817 for Sections and elevations
  830 for Location of external wall, floor and roof details
  831-859 for External wall, floor and roof details
  831-859 for External wall, floor and roof details
  880-861 for Internal partition details
  870-879 for Internal elevations
  880-885 for Sanitary ware and WC setting out
  880-885 for Window and door schedules
  M&E co-ordination in abeyance pending completion of M&E model
  Refer to landscape architect, M&E engineer and structural engineer of the landscape, M&E and structural details and specification.

DETAIL KEY: ----- J40/270A FULLY BONDED BITUMEN DAMP PROOFING/

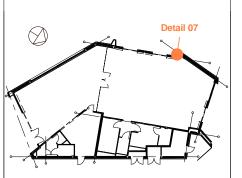TANKING

J40/120 LOOSE LAID POLYETHYLENE DAMP PROOFING

PROPRIETARY ROOF MEMBRANE PI0/310A VAPOUR CONTROL LAYER

- H21/130 BREATHER MEMBRANE J40/380 PROTECTION BOARDS FOR DAMP PROOFING/ TANKING





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DESCRIPTION ISSUE DATE DRAWN CHECKED

CLIENT Nottingham City Council

PROIECT

DRAWING TITLE External Envelope Detail 07

SIZE & SCALE 1:5 @ A1


DRAWING STATUS For Pre-Tender Estimate

JOB NUMBER 235350/1

DRAWING NO.

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REVISION

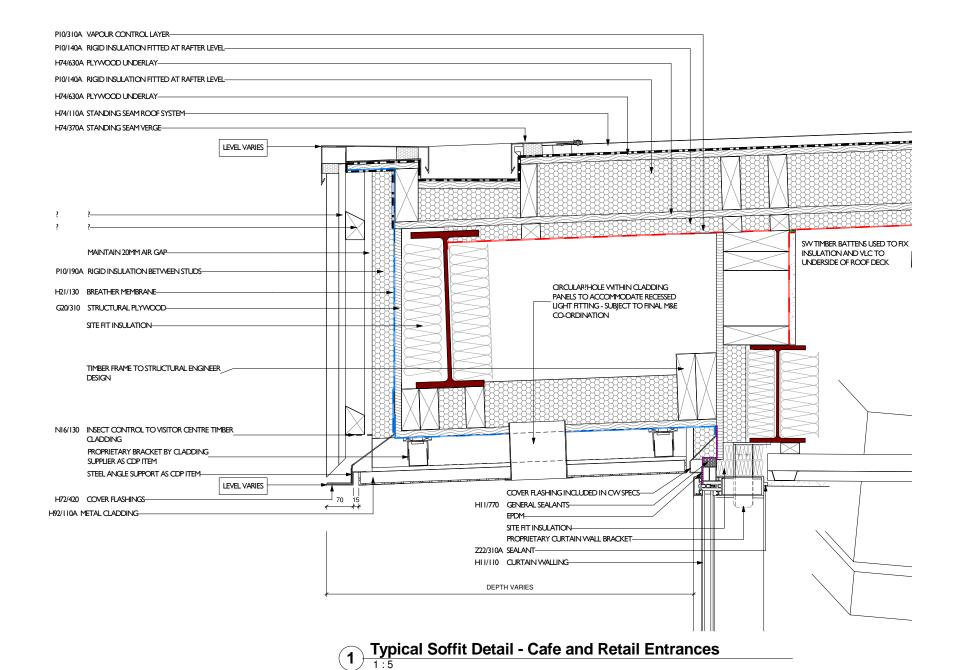

Notes:


Drawings are based on survey data and may not accurately represent what is physically present.

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Key Plan not to scale



- NOTES:

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  Drawings to be read in conjunction with all other consultant's documentation.
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  Line of thermal insulation to be complete with no voids and/or gaps present.
  Ensure that all structure located on line of thermal insulation is fully
- Ensure that all structure located on line of thermal insulation is fully insulated.

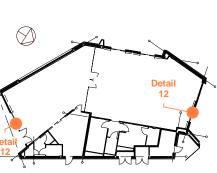  Refer to: 800-805 for GA Plans and finishes 806-807 for Internal Wall and Cladding types 810-817 for Sections and elevations 830 for Location of external wall, floor and roof details 831-859 for External wall, floor and roof details 860-861 for Internal partition details 870-879 for Internal elevations 880-885 for Sanitary ware and WC setting out 890-895 for Window and door schedules

  M&E co-ordination in abeyance pending completion of M&E model

  Refer to landscape architect, M&E engineer and structural engineer details for landscape, M&E and structural details and specification.

DETAIL KEY:

J40270A FULLY BONDED BITUMEN DAMP PROOFING/
TANKING
LOOSE LAID POLYETHYLENE DAMP PROOFING
BDM
PROPRIETARY ROOF MEMBRANE

P10/310A VAPOUR CONTROL LAYER

H21/130 BREATHER MEMBRANE PROTECTION BOARDS FOR DAMP PROOFING/ TANKING





1 07/04/17 LH Issued for Pre-Tender Estimate

Nottingham City Council

Nottingham Castle Visitor Centre

PROIECT

ISSUE DATE DRAWN CHECKED CLIENT

DRAWING TITLE Typical Soffit Detail 01

SIZE & SCALE 1:5 @ A1

DRAWING STATUS For Pre-Tender Estimate

JOB NUMBER 235350/1

DRAWING NO.


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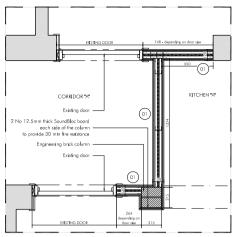
REVISION



DESCRIPTION





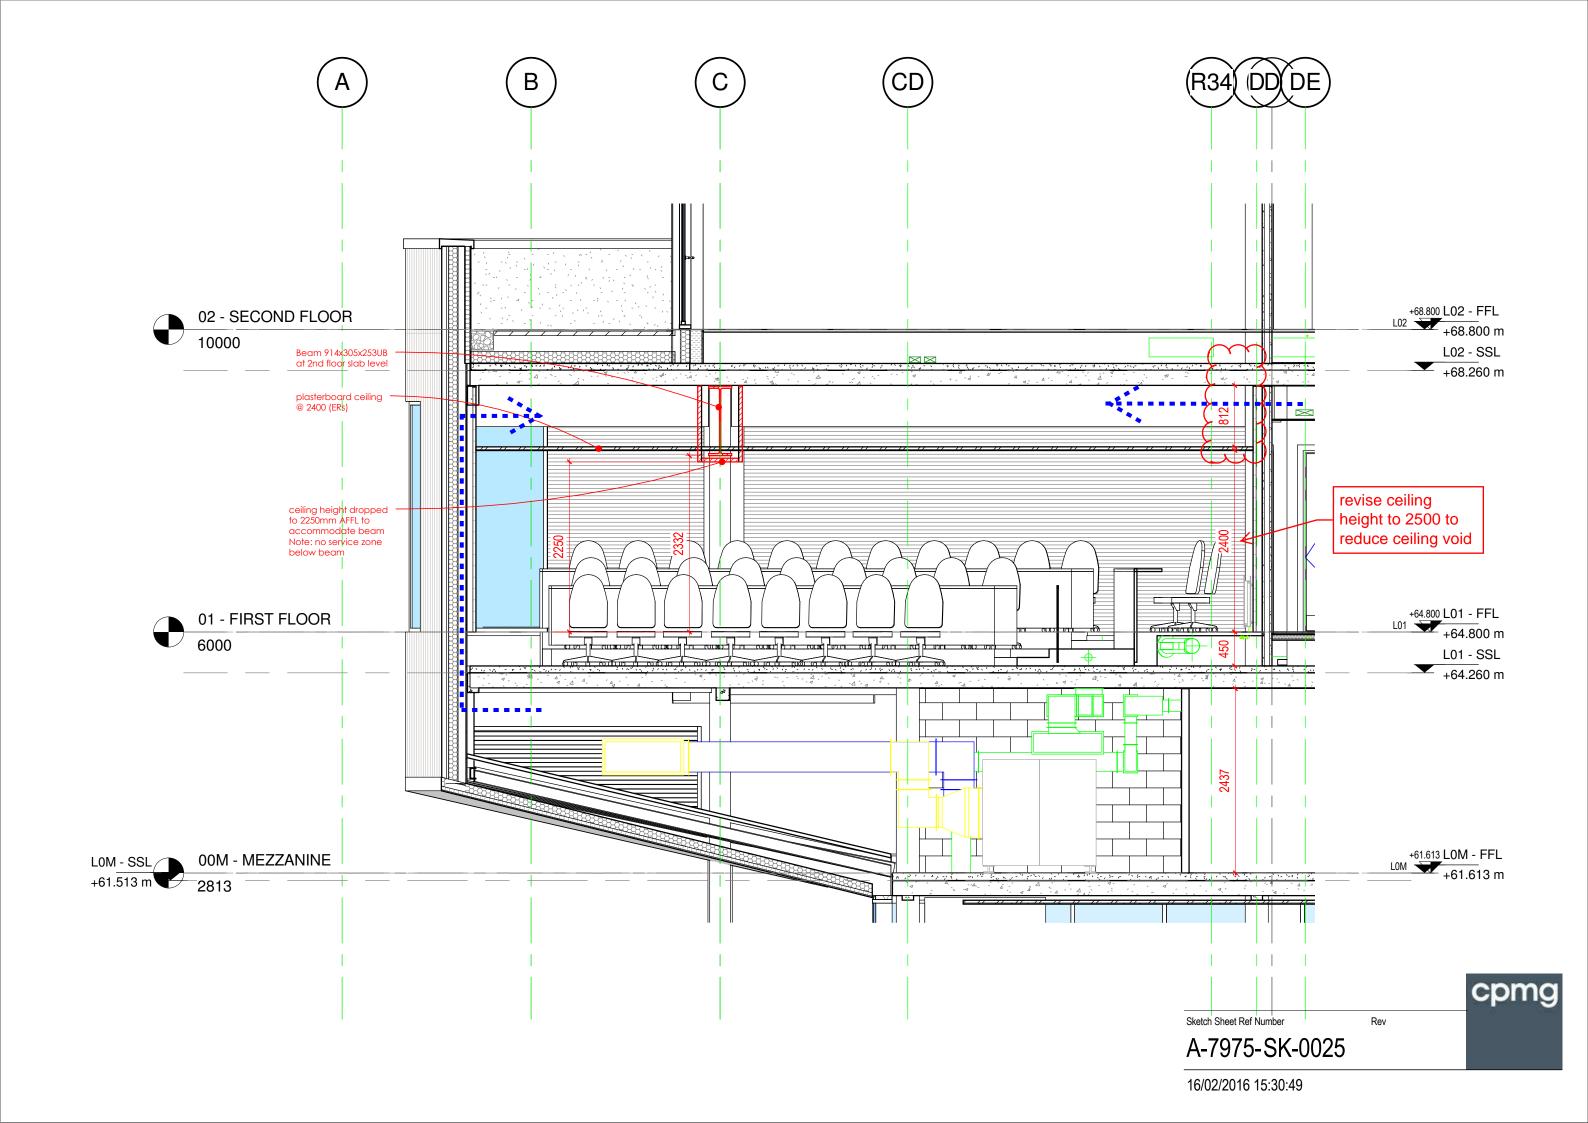


DETAIL A WALL TYPE 01 - scale 1:20

WALL TYPE 01 2x 12.5mm BG SoundBloc board 70mm C studs at 600mm centres

25mm Isover APR 1200 insulation within studwork

2x 12.5mm BG SoundBloc board

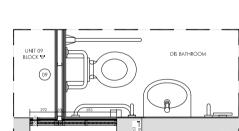

DETAIL F WALL TYPE 09 / 10 - scale 1:20

WALL TYPE 09 2x 12.5mm BG wall board

(10)

50mm C studs at 600mm centres 1x 18mm Flame Retardant EURO CLASS B plywood board

1x 12.5mm BG SoundBloc MR board


Turm rilling (wherever necessory)
1x 12.5mm BG SoundBloc MR board
1x 18mm Flame Retardant EURO CLASS B plywood board
75mm C studs at 600mm centres

75mm C studs of routume centres 25mm Isover APR 1200 insulation within studwork Covity void (width depending on the existing wall) 25mm Isover APR 1200 insulation within studwork

75mm C studs at 600mm centres 1x 18mm Flame Retardant EURO CLASS B plywood board

1x 12.5mm BG SoundBloc MR board

DriLyner RF system 1x 52mm BG TriLine sound insulating laminate

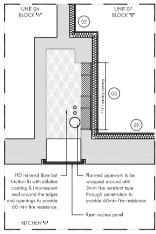

DETAIL B WALL TYPE 02 / 03 - scale 1:20

WALL TYPE 02


DriLyner RF system
1x 52mm BG TriLine sound insulating laminate

WALL TYPE 03

1x 52mm BG Trilline sound insulation laminate

1x 12.5 mm BG wall board

1x 102mm solid brick wall to provide 60min fire resistance

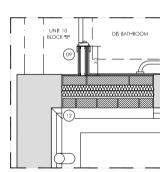

DETAIL H WALL TYPE 12 - scale 1:20


WALL TYPE 12
10mm tilling (wherever necessary)
100mm block work (to flush with the existing wall)

Waterproof membrane

80mm Isover APR 1200 insulation within studwork

Breathable membrane

Cavity void (width depending on the existing wall) 102mm external brickwork (to match existing)

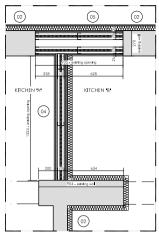

DETAIL C WALL TYPE 04 / 05 - scale 1:20

WALL TYPE 04 1x 15mm BG FireLine board

1x 18mm Flame Retardant EURO CLASS B plywood board

70mm C studs at 600mm centres 25mm Isover APR 1200 insulation within studwork

1x 18mm Flame Retardant EURO CLASS B plywood board

1x 15mm BG FireLine board

WALL TYPE 05


DriLyner RF system
1x 52mm BG TriLine sound insulating laminate

2v 12 5mm BG SoundBloc board

70mm C studs at 600mm centres 25mm Isover APR 1200 insulation within studwork

Cavity void (width depending on the existing wall)
25mm Isover APR 1200 insulation within studwork

70mm C studs at 600mm centres 2x 12.5mm BG SoundBloc board

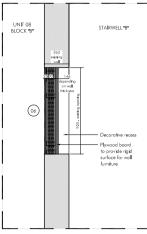


DETAIL D WALL TYPE 06 - scale 1:20

WALL TYPE 06 2x 12.5mm BG SoundBloc board 92mm C studs at 600mm centres

3v 25mm Isover APR 1200 insulation within studyork

x 18mm Flame Retardant EURO CLASS B plywood board

1x 15mm BG Fireline board

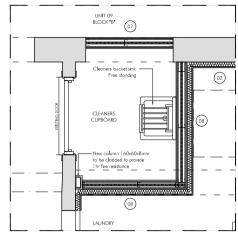

DETAIL E WALL TYPE 07 / 08 - scale 1:20

WALL TYPE 07 2x 12.5mm BG SoundBloc board 70mm C studs at 600mm centres

25mm Isover APR 1200 insulation within studwork

1x 12.5mm BG SoundBloc board 1x 12.5mm BG SoundBloc MR board


WALL TYPE 08 1x 12.5mm BG SoundBloc MR board

1x 12.5mm BG SoundBloc board 70mm C studs at 600mm centres

25mm Isover APR 1200 insulation within studwork

1x 12.5mm BG SoundBloc MR board

1x 52mm BG TriLine sound insulating laminate

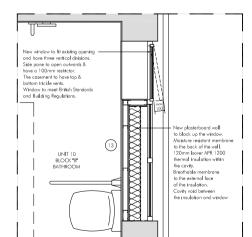



WALL TYPE 13

10mm tiling 1x 12.5mm BG MR wall board

50mm C studs at 600mm centres x 12.5mm BG MR wall board

Water proof membrane

Cavity void

120mm Isover 1200 APR thermal insulation Breathable membrane



(02)

\* ALL JUNCTIONS TO FLOORS, WALLS AND CEILINGS TO BE SEALED WITH INTUMESCENT/SOUND SEALANT.

\* ALL BOARDS STAGGERED AND FITTED IN ACCORDANCE WITH MANUFACTURER INSTRUTIONS AND SCREW TYPES.

\* ALL WALLS TO BE 30min FIRE RATED UNLESS STATED OTHERWISE

\* SEE GENERAL ARRANGEMENT DRAWINGS FOR ROOM TYPE LOCATION


\* ALL STEELWORK TO HAVE 1 hr FIRE PROTECTION





(21)001

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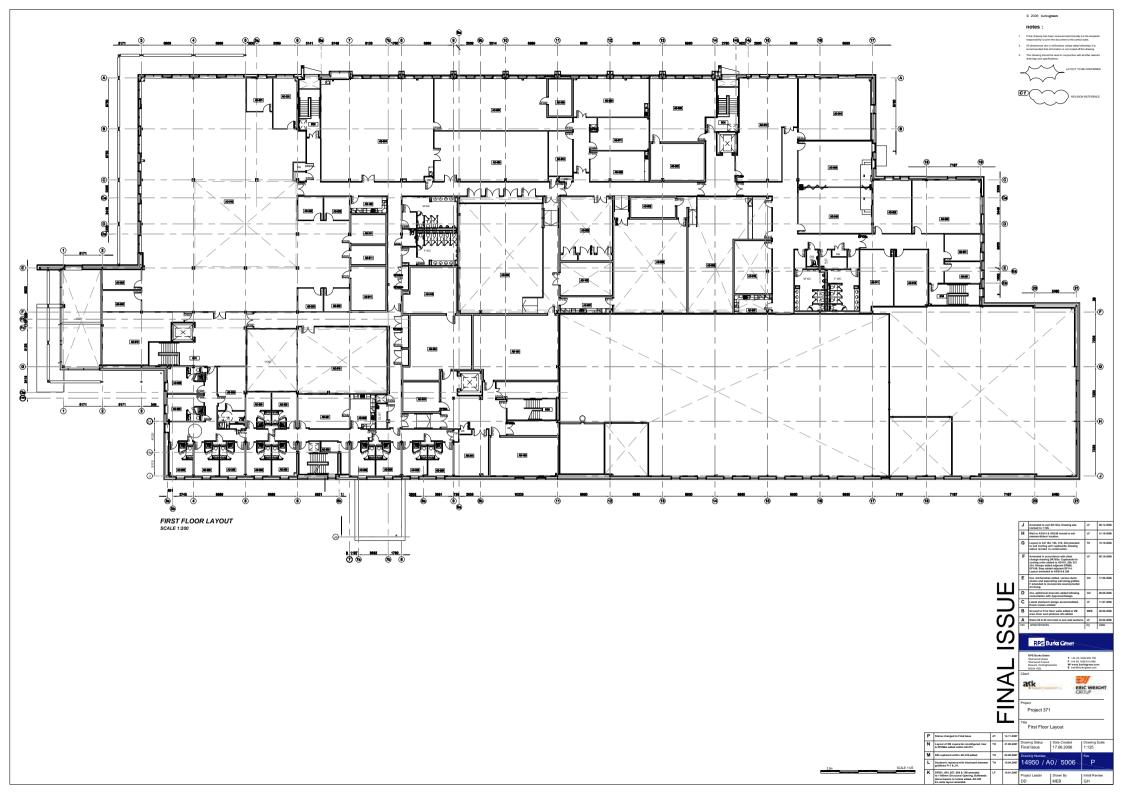


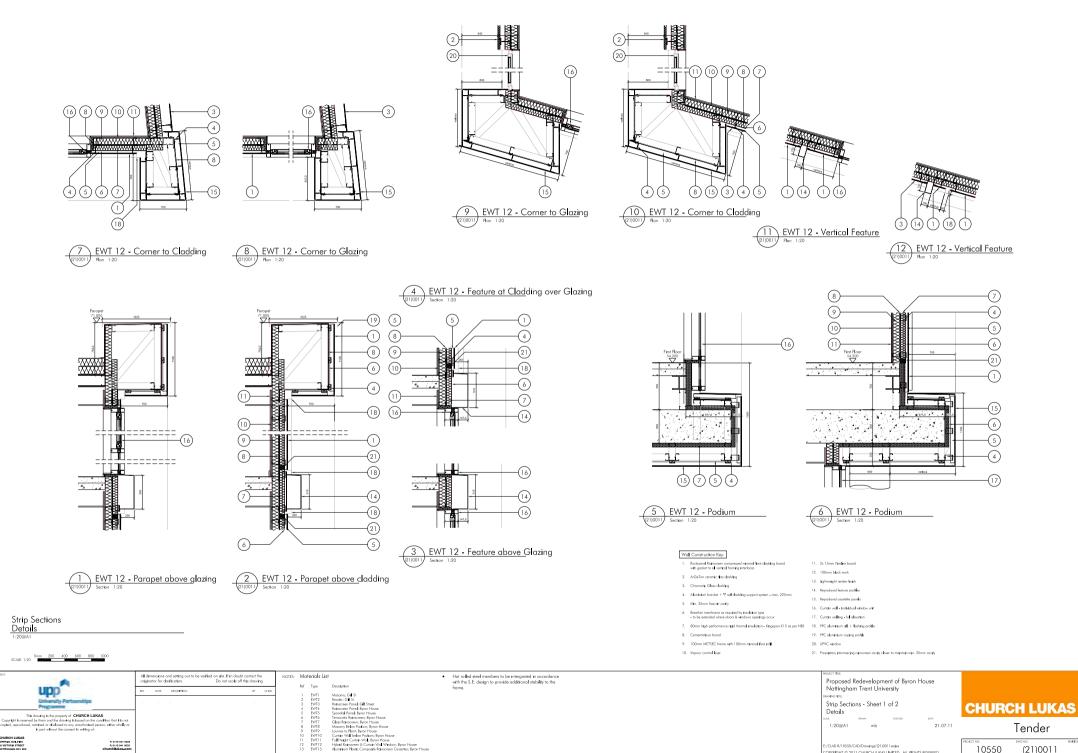
CHURCH LUKAS IMPERIAL BULDING SO VICTORIA STREET HOTTINGHAM HG1 2EX

10550 (21)0011

:/CIAD R/10550/CAD/Drowings/(21)0011series

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Cladding Section Details / Sheet 2 3. Gridline intersection A7-12 4. Gridline intersection A12-14 12.06.2006 14950 / A0 / 5341

ask

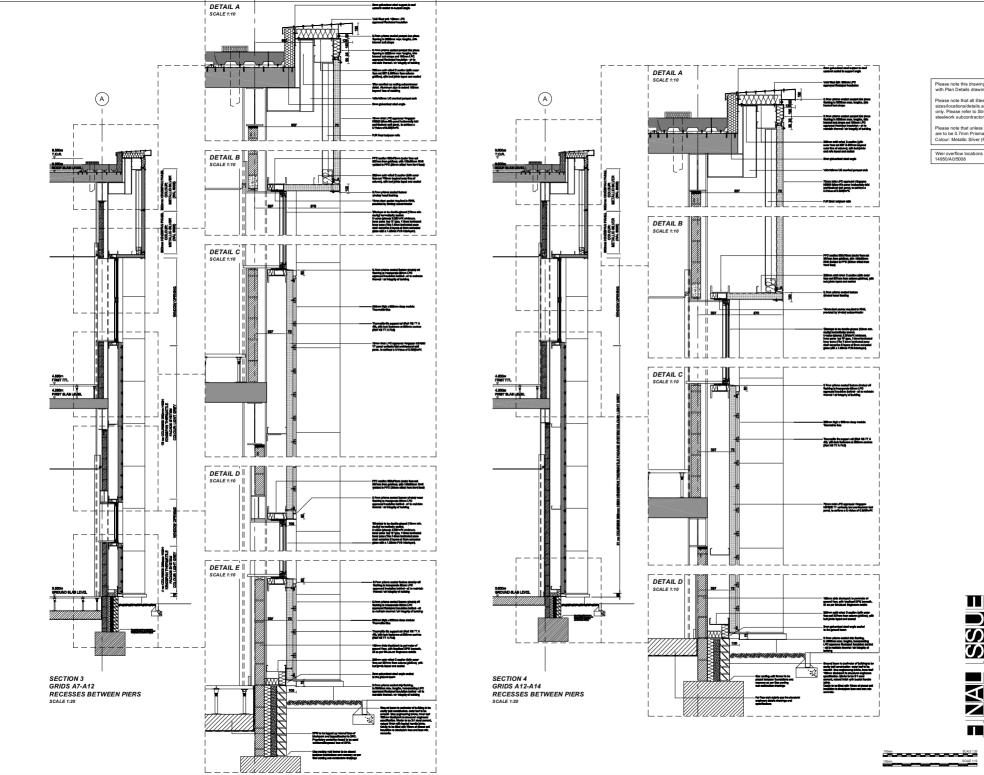ERIC WRIGHT GROUP

Please note this drawing is to be read in conjunction with Plan Details drawing nos. 14950/A0/5350 & 5351.

Please note that all Steelwork, Sheeting Rail sizes/locations/details and foundations are indicative only. Please refer to Structure Engineers and steelwork subcontractor information

Please note that unless stated otherwise, all flashings are to be 0.7mm Prisma coated.
Colour: Metallic Silver (RAL 9006)

Weir overflow locations see Roof Plan drawing no 14950/A0/5008

